2393.0 SOUTH CAMPUS PARKING LOT UNIVERSITY OF KENTUCKY

LEXINGTON, KENTUCKY **APRIL 2014**





STAGGS & FISHER CONSULTING ENGINEERS, INC. 3264 LOCHNESS DRIVE LEXINGTON, KY 40517




ABBIE JONES CONSULTING 1022 FONTAINE ROAD LEXINGTON, KY 40502


sfengineering.com

RECORD DRAWINGS

ON INFORMATION COMPILED AND FURNISHED BY OTHERS. THE ENGINEER HAS NOT VERIFIED THE ACCURACY AND/OR COMPLETENESS OF THIS INFORMATION AND SHALL NOT BE RESPONSIBLE FOR ANY ERRORS OR OMISSIONS WHICH MAY BE INCORPORATED HEREIN AS A RESULT.

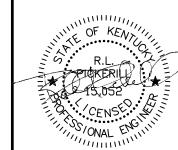



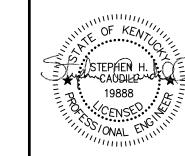

FACSIMILES OF LICENSED PROFESSIONAL ENGINEER AND/OR LAND SURVEYOR SEALS, IF AFFIXED TO THIS DOCUMENT, SHALL BE CONSIDERED LEGITIMATE ONLY IF SIGNED AND DATED BY THE REGISTRANT.

BUD NOTE:

KENTUCKY STATUTES (KRS 367.4901 THROUGH 367.4917) REQUIRE THAT ALL EXCAVATORS PLANNING EXCAVATION OR DEMOLITION WORK SHALL NOTIFY ALL UTILITY COMPANIES IN THE AREA AND/OR AN UNDERGROUND PROTECTION SERVICE SUCH AS BUD (1-800-752-6007 OR 811) AT LEAST TWO (2) WORKING DAYS BEFORE COMMENCING WORK TO ALERT UTILITY COMPANIES IN THE AREA WITH UNDERGROUND FACILITIES OF THE PLANNED EXCAVATION OR DEMOLITION

SCHEMATIC DESIGN

DESIGN DEVELOPMENT

UK REVIEW 95% BELL REVIEW

BID DOCUMENTS

RECORD DRAWINGS



2480 fortune drive, suite 350 lexington, kentucky 40509 P: 859-278-5412 | F: 859-278-2911 www.hkbell.com



THESE RECORD DRAWINGS HAVE BEEN PREPARED BASED

VICINITY MAP

NOT TO SCALE

INDEX OF DRAWINGS

GENERAL

G01 **COVER SHEET**

G02 INDEX OF DRAWINGS, GENERAL NOTES & LEGENDS

CIVIL

EROSION CONTROL - SEDIMENT CONTROL PLAN C10

C11 **EROSION CONTROL - STANDARD DETAILS**

C12 **EROSION CONTROL - MISCELLANEOUS DETAILS**

C20 **DEMOLITION PLAN**

C30 SITE LAYOUT

HANDICAP SIDEWALK/RAMP AND PARKING LAYOUT C30.1

C31 SITE DETAILS

C40 GRADING & DRAINAGE PLAN

C41 STORM PIPE PROFILES

C42 DRAINAGE STRUCTURE DETAILS

UTILITIES

U10 SITE UTILITIES PLAN

LANDSCAPING

L10 LANDSCAPING PLAN L11 LANDSCAPING DETAILS

CONTROL POINTS

SEE SHEET C30 FOR CONTROL POINTS.

BEFORE YOU DIG - CALL 811

*KENTUCKY STATUTES (KRS 367.4903 THROUGH 367.4917) REQUIRE THAT ALL EXCAVATORS PLANNING EXCAVATION OR DEMOLITION WORK SHALL CALL ALL UTILITY COMPANIES IN THE AREA AND/OR AN UNDERGROUND PROTECTIONS SERVICE SUCH AS "BUD" (1-800-752-6007) NOT LESS THAN TWO (2) BUSINESS DAYS NOR MORE THAN TEN (10) BUSINESS DAYS PRIOR TO COMMENCING WORK TO NOTIFY UTILITY COMPANIES IN THE AREA WITH UNDERGROUND FACILITIES OF THE PLANNED EXCAVATION OR DEMOLITION ACTIVITIES.

UTILITIY OWNERS

KENTUCKY AMERICAN WATER COMPANY 2300 RICHMOND ROAD LEXINGTON, KENTUCKY 40502 PHONE: 859-268-6357

COLUMBIA GAS OF KENTUCKY P.O. BOX 241 LEXINGTON, KENTUCKY PHONE: 859-288-0243

KENTUCKY UTILITIES 500 STONE ROAD LEXINGTON, KENTUCKY 40503 PHONE: 859-278-9355

LEXINGTON-FAYETTE URBAN COUNTY GOVERNMENT DIVISION OF WATER QUALITY 125 LISLE INDUSTRIAL AVENUE, SUITE 180 LEXINGTON, KENTUCKY 40511

LEGEND

EXISTING OVERHEAD ELECTRIC

EXISTING UNDERGROUND ELECTRIC

EXISTING STORM SEWER

EXISTING GAS LINE

EXISTING WATER LINE

EXISTING LIGHT POLE

EXISTING CONTOURS

EXISTING TREES

DRAIN INLET CURB INLET

TOP OF STEP

DO NOT DISTURB

HEADWALL

SILT FENCE

PROPOSED CONTOURS

PROPOSED STORM SEWER

DRAINAGE (direction of flow)

TREE PROTECTION FENCING

LIMITS OF DISTURBANCE

EXISTING BOLLARDS EXISTING RIPRAP

PROPOSED RIPRAP

EXISTING MANHOLE PROPOSED MANHOLE

TEMPORARY DIVERSION DITCH

EXISTING TREE OR BUSH TO BE REMOVED

CABLE TELEVISION

—OHE—

-STORM-—GAS—

— CTV —

— WL —

---1024----

---1024----

TS

DND

—UGE —OR—12KV—

PHONE: 859-425-2255 859-425-2400

UNIVERSITY OF KENTUCKY PHYSICAL PLANT DIVISION 225 PETERSON SERVICE BUILDING LEXINGTON, KENTUCKY 40506

PHONE: 859-257-5929

WATER SEWER STORM


POWER COMMUNICATION


RECORD DRAWINGS

THESE RECORD DRAWINGS HAVE BEEN PREPARED BASED ON INFORMATION COMPILED AND FURNISHED BY OTHERS. THE ENGINEER HAS NOT VERIFIED THE ACCURACY AND/OR COMPLETENESS OF THIS INFORMATION AND SHALL NOT BE RESPONSIBLE FOR ANY ERRORS OR OMISSIONS WHICH MAY BE INCORPORATED HEREIN AS A RESULT.

DESIGNER	RLP	DATE	BY	REVISION		Ī
DRAWN	DRH				GRAPHIC SCALE	IN C
CHECKED	AGC					F
APPROVED	RLP				SCALE: NONE	T C

THIS DOCUMENT IS THE PROPERTY OF BEL ENGINEERING AND SHALL NOT BE REPRODUCED IN WHOLE OR IN PART OR USED FOR CONSTRUCTION OF OTHER THAN THIS SPECIFIC PROJECT WITHOUT THE WRITTEN PERMISSION OF BELL ENGINEERING FACSIMILES OF LICENSED PROFESSIONAL ENGINEER AND/OR LAND SURVEYOR SEALS, IF AFFIXED TO THIS DOCUMENT, SHALL BE CONSIDERED LEGITIMATE

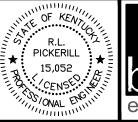


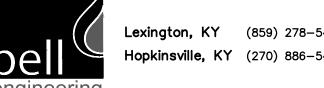

2393.0 SOUTH CAMPUS PARKING LOT CAPITAL PROJECT MANAGEMENT DIVISION UNIVERSITY OF KENTUCKY LEXINGTON, KENTUCKY

INDEX OF DRAWINGS,

DIVISION G	ENERAL
CONTRACT NO	600-037
DATE	APRIL 2014
SHEET NO.	G02

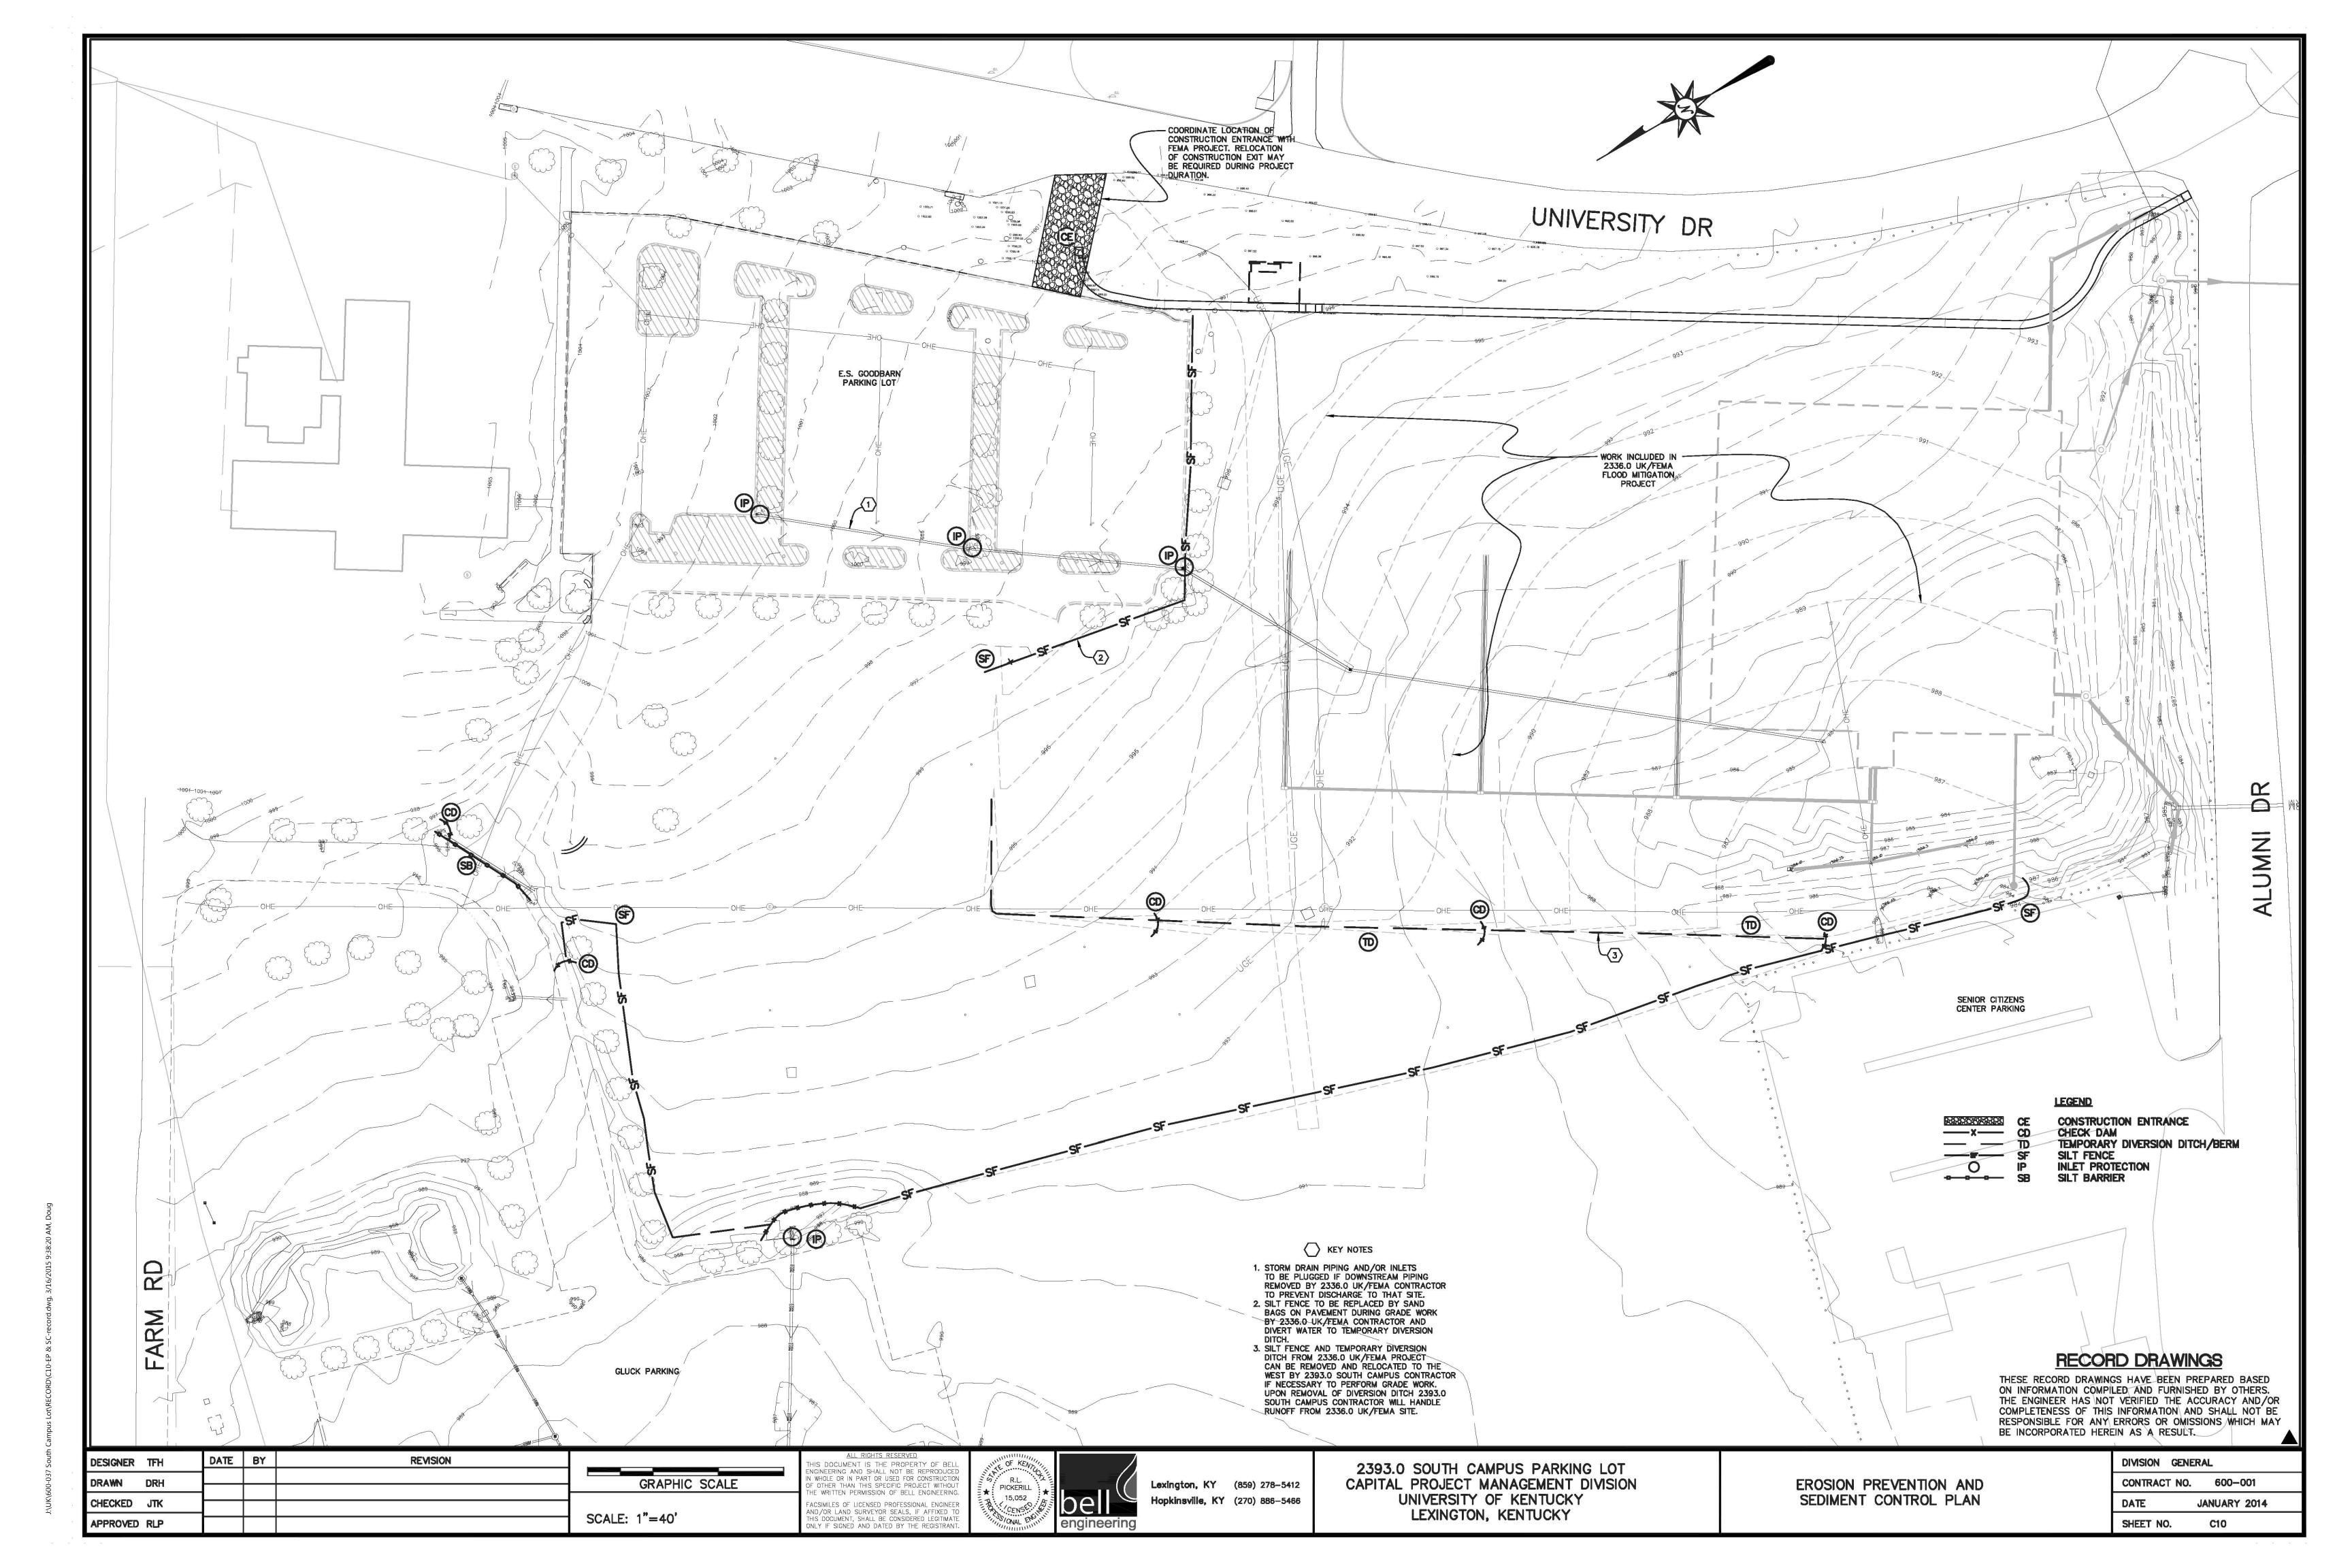

TER TEMPORARY SILT FENCE

(EFFECTIVE DATE 8/29/11)

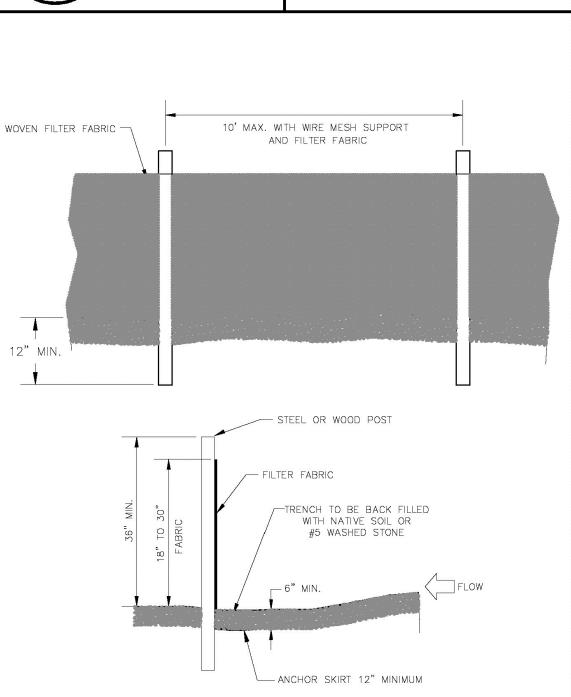




FIGURE 11-22


IWATER

TEMPORARY SILT FENCE
GENERAL NOTES

(EFFECTIVE DATE 8/29/11)

GENERAL NOTES


- FILTER FABRIC SHALL BE PURCHASED IN A CONTINUOUS ROLL AND CUT TO THE LENGTH OF THE BARRIER. WHEN JOINTS CANNOT BE AVOIDED, FILTER FABRIC SHALL BE SPLICED TOGETHER ONLY AT A POST WITH 3 FOOT MIN. OVERLAP, AND SECURELY SEALED.
- 2. POSTS SHALL BE SPACED AT 6 FOOT INTERVALS IN AREAS OF RAPID RUNOFF.
- 3. POSTS SHALL BE AT LEAST 5 FEET IN LENGTH.
- 4. STEEL POSTS SHALL HAVE PROJECTIONS FOR FASTENING WIRE AND FABRIC.
- 5. WOOD POSTS SHALL BE 2 INCHES BY 2 INCHES OR EQUIVALENT. STEEL POSTS SHALL BE 1.33 LBS PER LINEAR FOOT.
- 6. A WIRE MESH SUPPORT FENCE SHALL BE FASTENED SECURELY TO THE UPSLOPE SIDE OF THE POSTS USING HEAVY DUTY WIRE STAPLES AT LEAST 1 INCH IN LENGTH, WIRE TIES OR HOG RINGS. THE WIRE SHALL EXTEND INTO THE TRENCH A MINIMUM OF 2 INCHES AND SHALL NOT EXTEND MORE THAN 36 INCHES ABOVE THE ORIGINAL GROUND SURFACE.
- 7. WASHED STONE SHALL BE USED TO BURY SKIRT WHEN SILT FENCE IS USED ADJACENT TO A CHANNEL, CREEK, OR POND.
- 8. TURN SILT FENCE UP SLOPE AT ENDS.

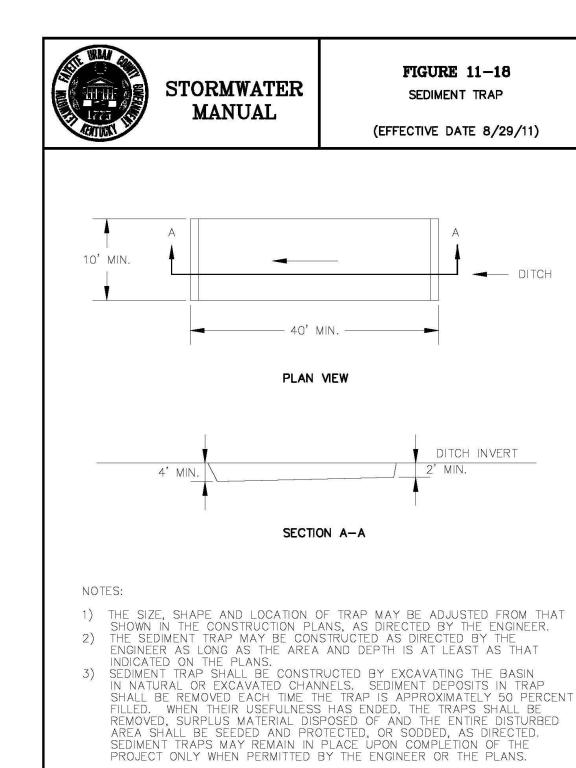



SOUTH CAMPUS PARKING PROJECT EROSION & SEDIMENT CONTROL NOTES

April. 20

- 1)Contractor shall prepare as a part of his construction scheduling plan an Erosion & Sediment Control plan. This plan shall indicate means of controlling erosion and sediment due to construction activities throughout the entire project. Guidance for preparing this document may be found in LFUCG Stormwater Manual, Chapter 11, and herein. Directives noted in these Plans and Specifications are not intended to dictate construction schedule. They are provided for Contractor's information and to illustrate how the project components are interrelated. Note that many erosion / sediment control BMPs require periodic inspection & maintenance. The Contractor is responsible for maintaining these BMPs throughout the course of the project. Because of the relationship between construction scheduling and erosion / sediment control, this Plan must by developed by the Contractor. This Plan will be submitted for review and approval by the Engineer, who will review for conformance with necessary erosion / sediment control performance. General requirements of the Erosion & Sediment Control Plan include the following:
- a.Control runoff around the construction sites, such that the effects of disturbing the ground surface are minimized on site and downstream.
- b.Construction is to be sequenced such that erosion and sediment transport is controlled. Some measures of accomplishing this are outlined herein.
- 2) Temporary Diversion Ditches are earthen ditches, with life expectancy of one year or less. They are used to divert flow around disturbed areas to reduce erosion and sedimentation. They shall be designed for the 10—year, 24—hour storm. They may be parabolic or trapezoidal in shape. V—shape ditches will not be allowed. The outlets of Temporary Diversion Ditches must be stabilized. Contractor is responsible for periodically cleaning ditches when sediment capacity has been depleted.
- 3) Silt Fencing is to be installed to protect areas downstream from construction and must be installed prior to disturbance in an area. They may be removed once all of the disturbed areas lying upstream have been stabilized. Details are included herein for the construction of silt fences. Contractor is responsible for periodic inspection and ensuring that they are in good working order throughout the project. Where silt control is required along pavement areas, use sand bag Silt Barriers when Silt Fencing cannot be used.
- 4) Stabilized construction entrances are required at all points of access for construction activity. They are to be placed in order to minimize disturbance for drivers and residents near the construction site. Construction entrances are required wherever vehicles are leaving a construction site and enter onto a public road and at any unpaved entrance/exit location where there is risk of transporting mud or sediment onto paved roads. They are to be constructed of a minimum of 6" thickness of #2 crushed stone laid over KYTC Type III filter fabric. They are to be at least 20 feet long and as wide as the entire width of the access. The entrance shall be inspected weekly and after there has been a high volume of traffic or a storm event greater than 0.2 inches. The entrance shall be maintained to prevent sediments being deposited onto public rights—of—way, which may require periodic top dressing with additional stone, or other measures, as—needed.
- 5) Erosion control blankets shall be used on recently planted slopes to protect seedlings until they become established. Acceptable products include mulch netting and erosion control matting. In all cases, the Contractor shall perform periodic inspection to ensure proper performance & shall complete any necessary repairs. LFUCG Figures 11—1, 5, 6 & 7 provide guidance for using erosion control matting on slopes.
- 6) Concrete washout pits shall be constructed to minimize the discharge of pollutants into streams. They shall be sized approximately 20' x 20' x 5' and provided in sufficient quantities according to concrete placement within an area. They are to be maintained in good working order by the Contractor throughout the project and be cleaned when they reach approximately 75% of their volume.
- 7) Inlet protection shall be provided at all storm drain inlets. The purpose of the inlet protection is to prevent sediment from entering storm drainage systems prior to permanent stabilization of the disturbed area. They shall be constructed in a manner that will facilitate cleanout and disposal of trapped sediment and minimize interference with construction activities. LFUCG Figures 11—23 and 24 provide guidance for constructing inlet
- 8) Check dams are small temporary dams constructed across a swale or drainage ditch. They are used to reduce the velocity off concentrated stormwater flows in order to reduce its erosion. The check dam will also trap small amounts of sediment, but is not considered as a sediment—trapping practice. Their use is limited to small, open channels that drain 5 acres or less. Check dams may be constructed of stones with filter fabric or sand bag filters and are limited in height to two feet.

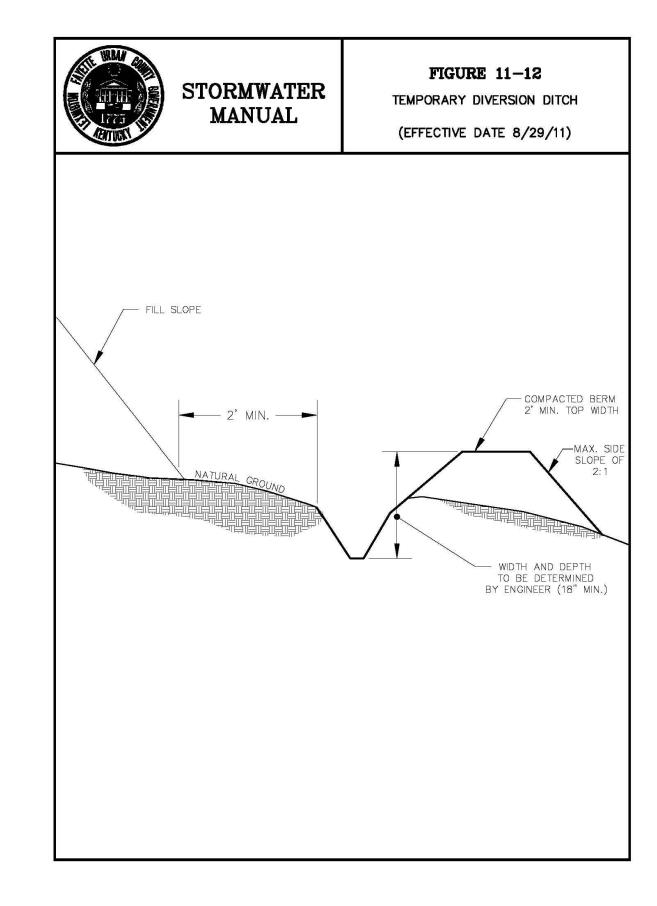

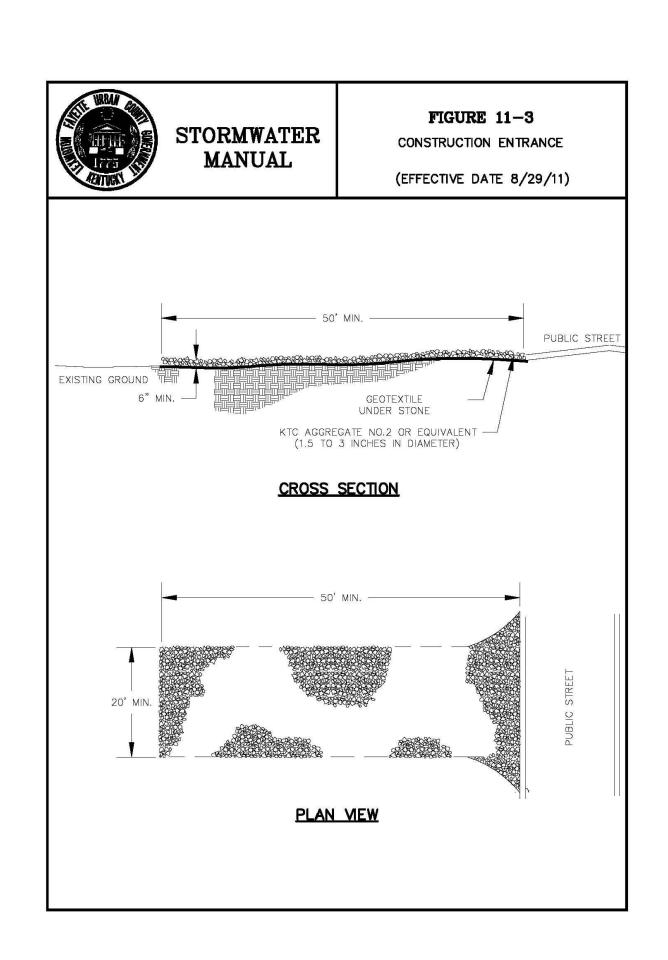

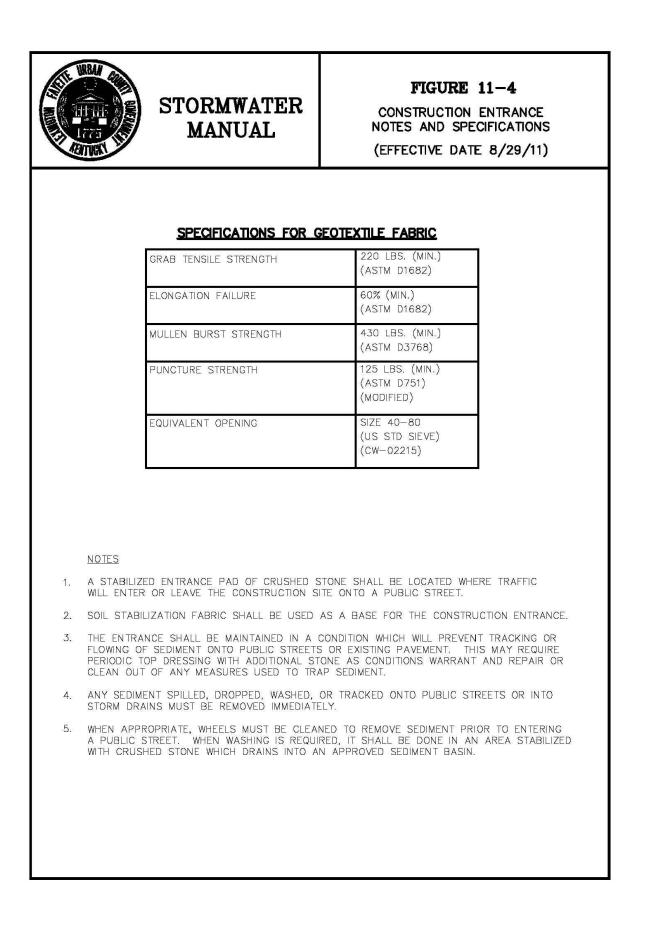

RECORD DRAWINGS

THESE RECORD DRAWINGS HAVE BEEN PREPARED BASED ON INFORMATION COMPILED AND FURNISHED BY OTHERS. THE ENGINEER HAS NOT VERIFIED THE ACCURACY AND/OR COMPLETENESS OF THIS INFORMATION AND SHALL NOT BE RESPONSIBLE FOR ANY ERRORS OR OMISSIONS WHICH MAY BE INCORPORATED HEREIN AS A RESULT.

DESIGNER	DMH	DATE	BY	REVISION			, l	THI
DRAWN	DRH				G	RAPHIC SCALE		ENC IN V
CHECKED	JTK							FAC
APPROVED	RLP				SCALE:	NONE		ANE THIS ONL

ALL RIGHTS RESERVED

THIS DOCUMENT IS THE PROPERTY OF BELL ENGINEERING AND SHALL NOT BE REPRODUCED IN WHOLE OR IN PART OR USED FOR CONSTRUCTION OF OTHER THAN THIS SPECIFIC PROJECT WITHOUT THE WRITTEN PERMISSION OF BELL ENGINEERING.

FACSIMILES OF LICENSED PROFESSIONAL ENGINEER AND/OR LAND SURVEYOR SEALS, IF AFFIXED TO THIS DOCUMENT, SHALL BE CONSIDERED LEGITIMATE ONLY IF SIGNED AND DATED BY THE REGISTRANT.







Lexington, KY (859) 278-5412 (
Hopkinsville, KY (270) 886-5466


2393.0 SOUTH CAMPUS PARKING LOT CAPITAL PROJECT MANAGEMENT DIVISION UNIVERSITY OF KENTUCKY LEXINGTON, KENTUCKY


EROSION & SEDIMENT CONTROL STANDARD DETAILS


DIVISION (GENERAL
CONTRACT NO	0. 600–037
DATE	APRIL 2014
SHEET NO.	C11

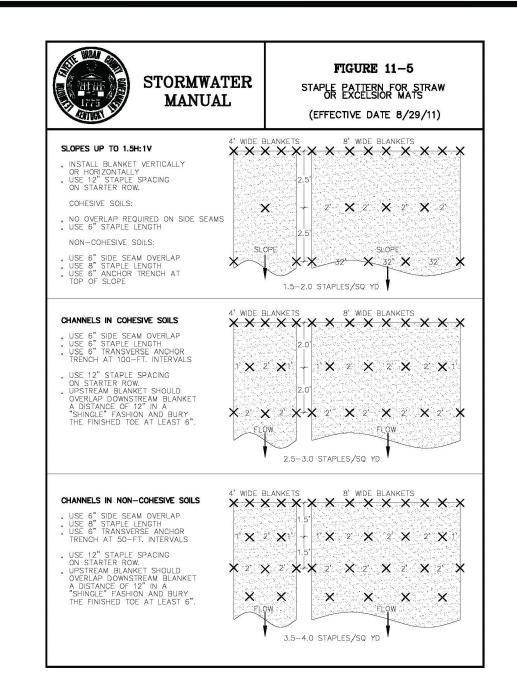


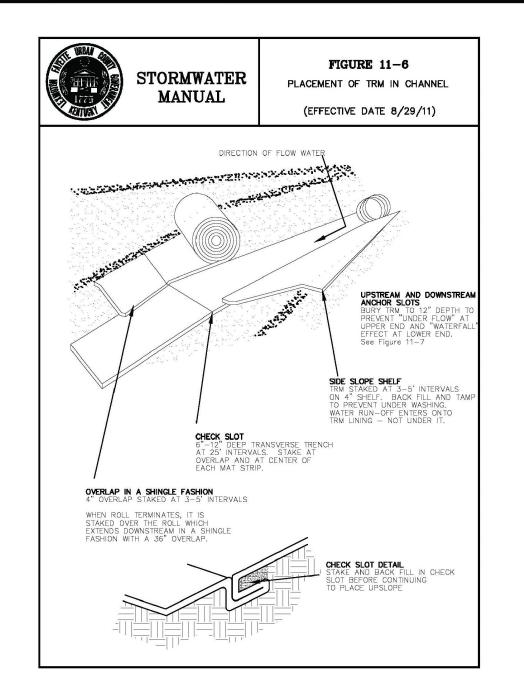


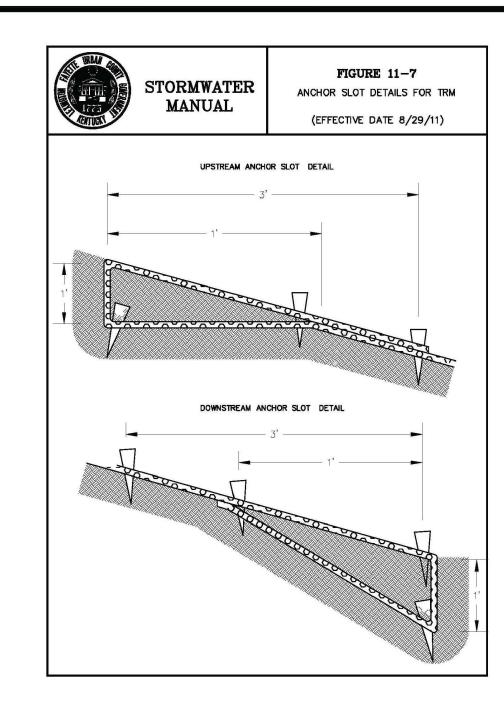


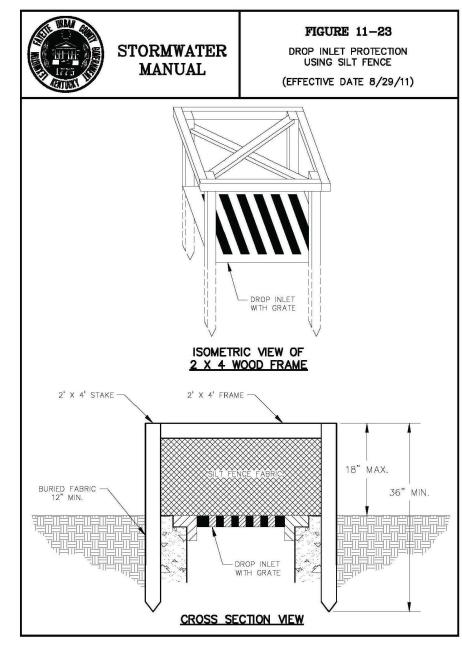


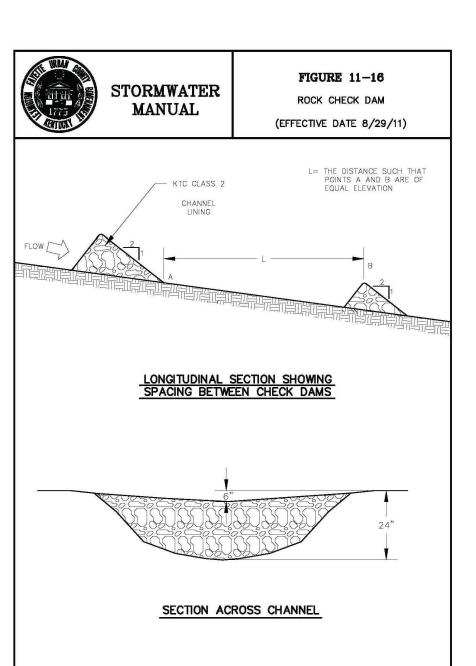

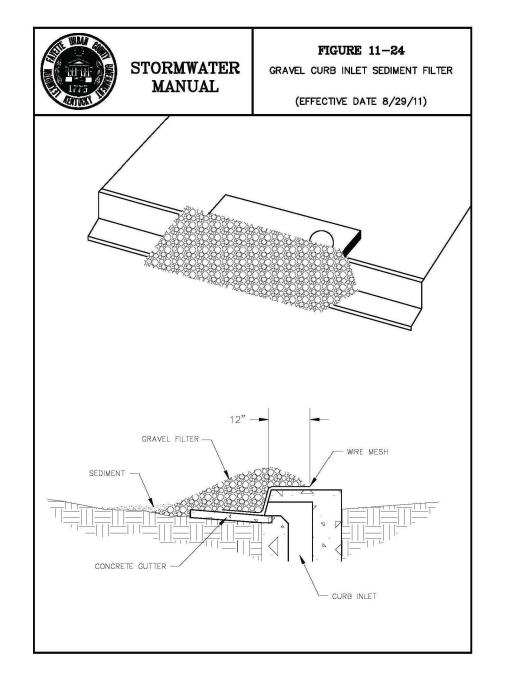

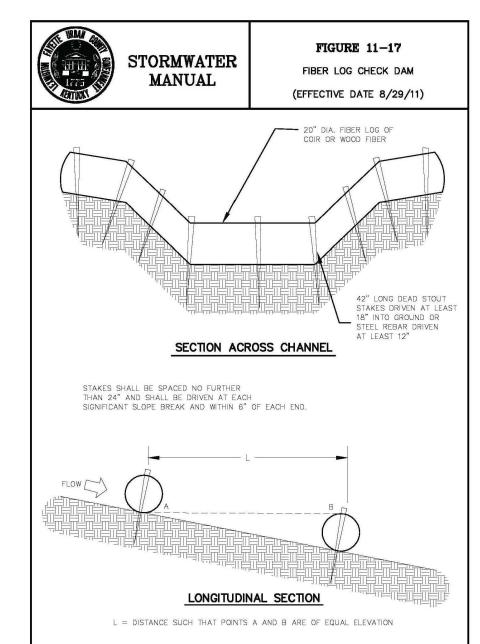

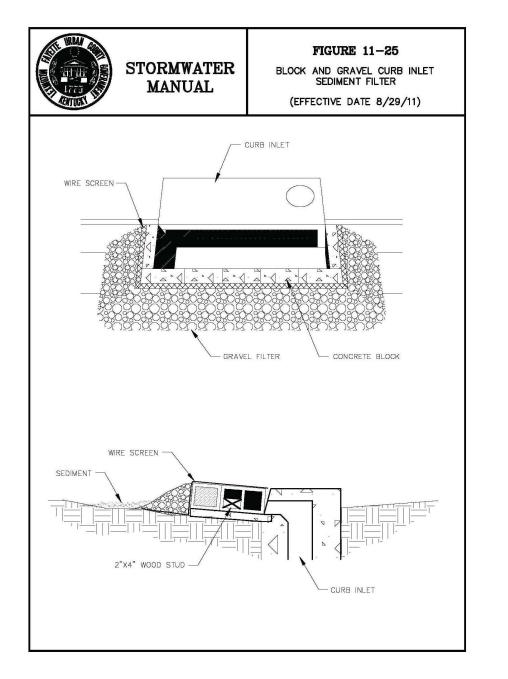

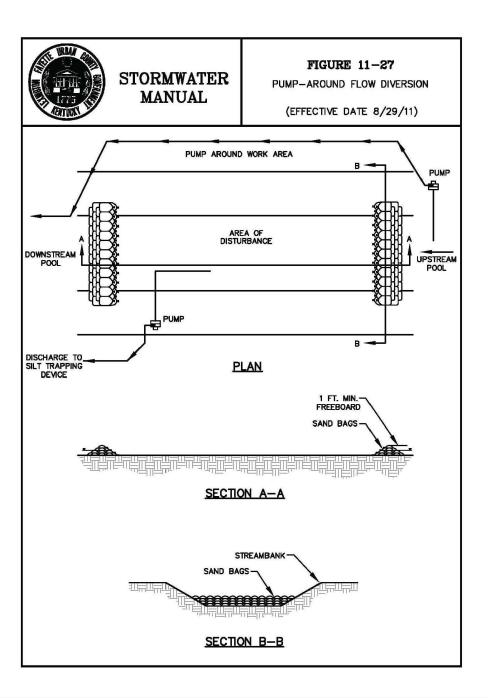


RECORD DRAWINGS

ON INFORMATION COMPILED AND FURNISHED BY OTHERS. THE ENGINEER HAS NOT VERIFIED THE ACCURACY AND/OR COMPLETENESS OF THIS INFORMATION AND SHALL NOT BE RESPONSIBLE FOR ANY ERRORS OR OMISSIONS WHICH MAY BE INCORPORATED HEREIN AS A RESULT.

DESIGNER	DMH	DATE	BY	REVISION		THIS D
DRAWN	DRH	<u> </u>			GRAPHIC SCALE	ENGINE IN WHOL OF OTH THE WR
CHECKED	JTK	 				FACSIMI
APPROVED	RLP				SCALE: NONE	AND/OF THIS DO ONLY IF
					de la companya de la	9

IIS DOCUMENT IS THE PROPERTY OF BELL GINEERING AND SHALL NOT BE REPRODUCED WHOLE OR IN PART OR USED FOR CONSTRUCTION OTHER THAN THIS SPECIFIC PROJECT WITHOUT E WRITTEN PERMISSION OF BELL ENGINEERING. CSIMILES OF LICENSED PROFESSIONAL ENGINEER D/OR LAND SURVEYOR SEALS, IF AFFIXED TO DOCUMENT, SHALL BE CONSIDERED LEGITIMATE Y IF SIGNED AND DATED BY THE REGISTRANT

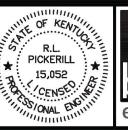





2393.0 SOUTH CAMPUS PARKING LOT CAPITAL PROJECT MANAGEMENT DIVISION UNIVERSITY OF KENTUCKY LEXINGTON, KENTUCKY


EROSION & SEDIMENT CONTROL MISCELLANEOUS DETAILS

DIVISION	GENERAL	
CONTRACT	NO.	600-037
DATE	APRIL	2014
SHEET NO.	C12	_
	<u>"</u>	

THESE RECORD DRAWINGS HAVE BEEN PREPARED BASED

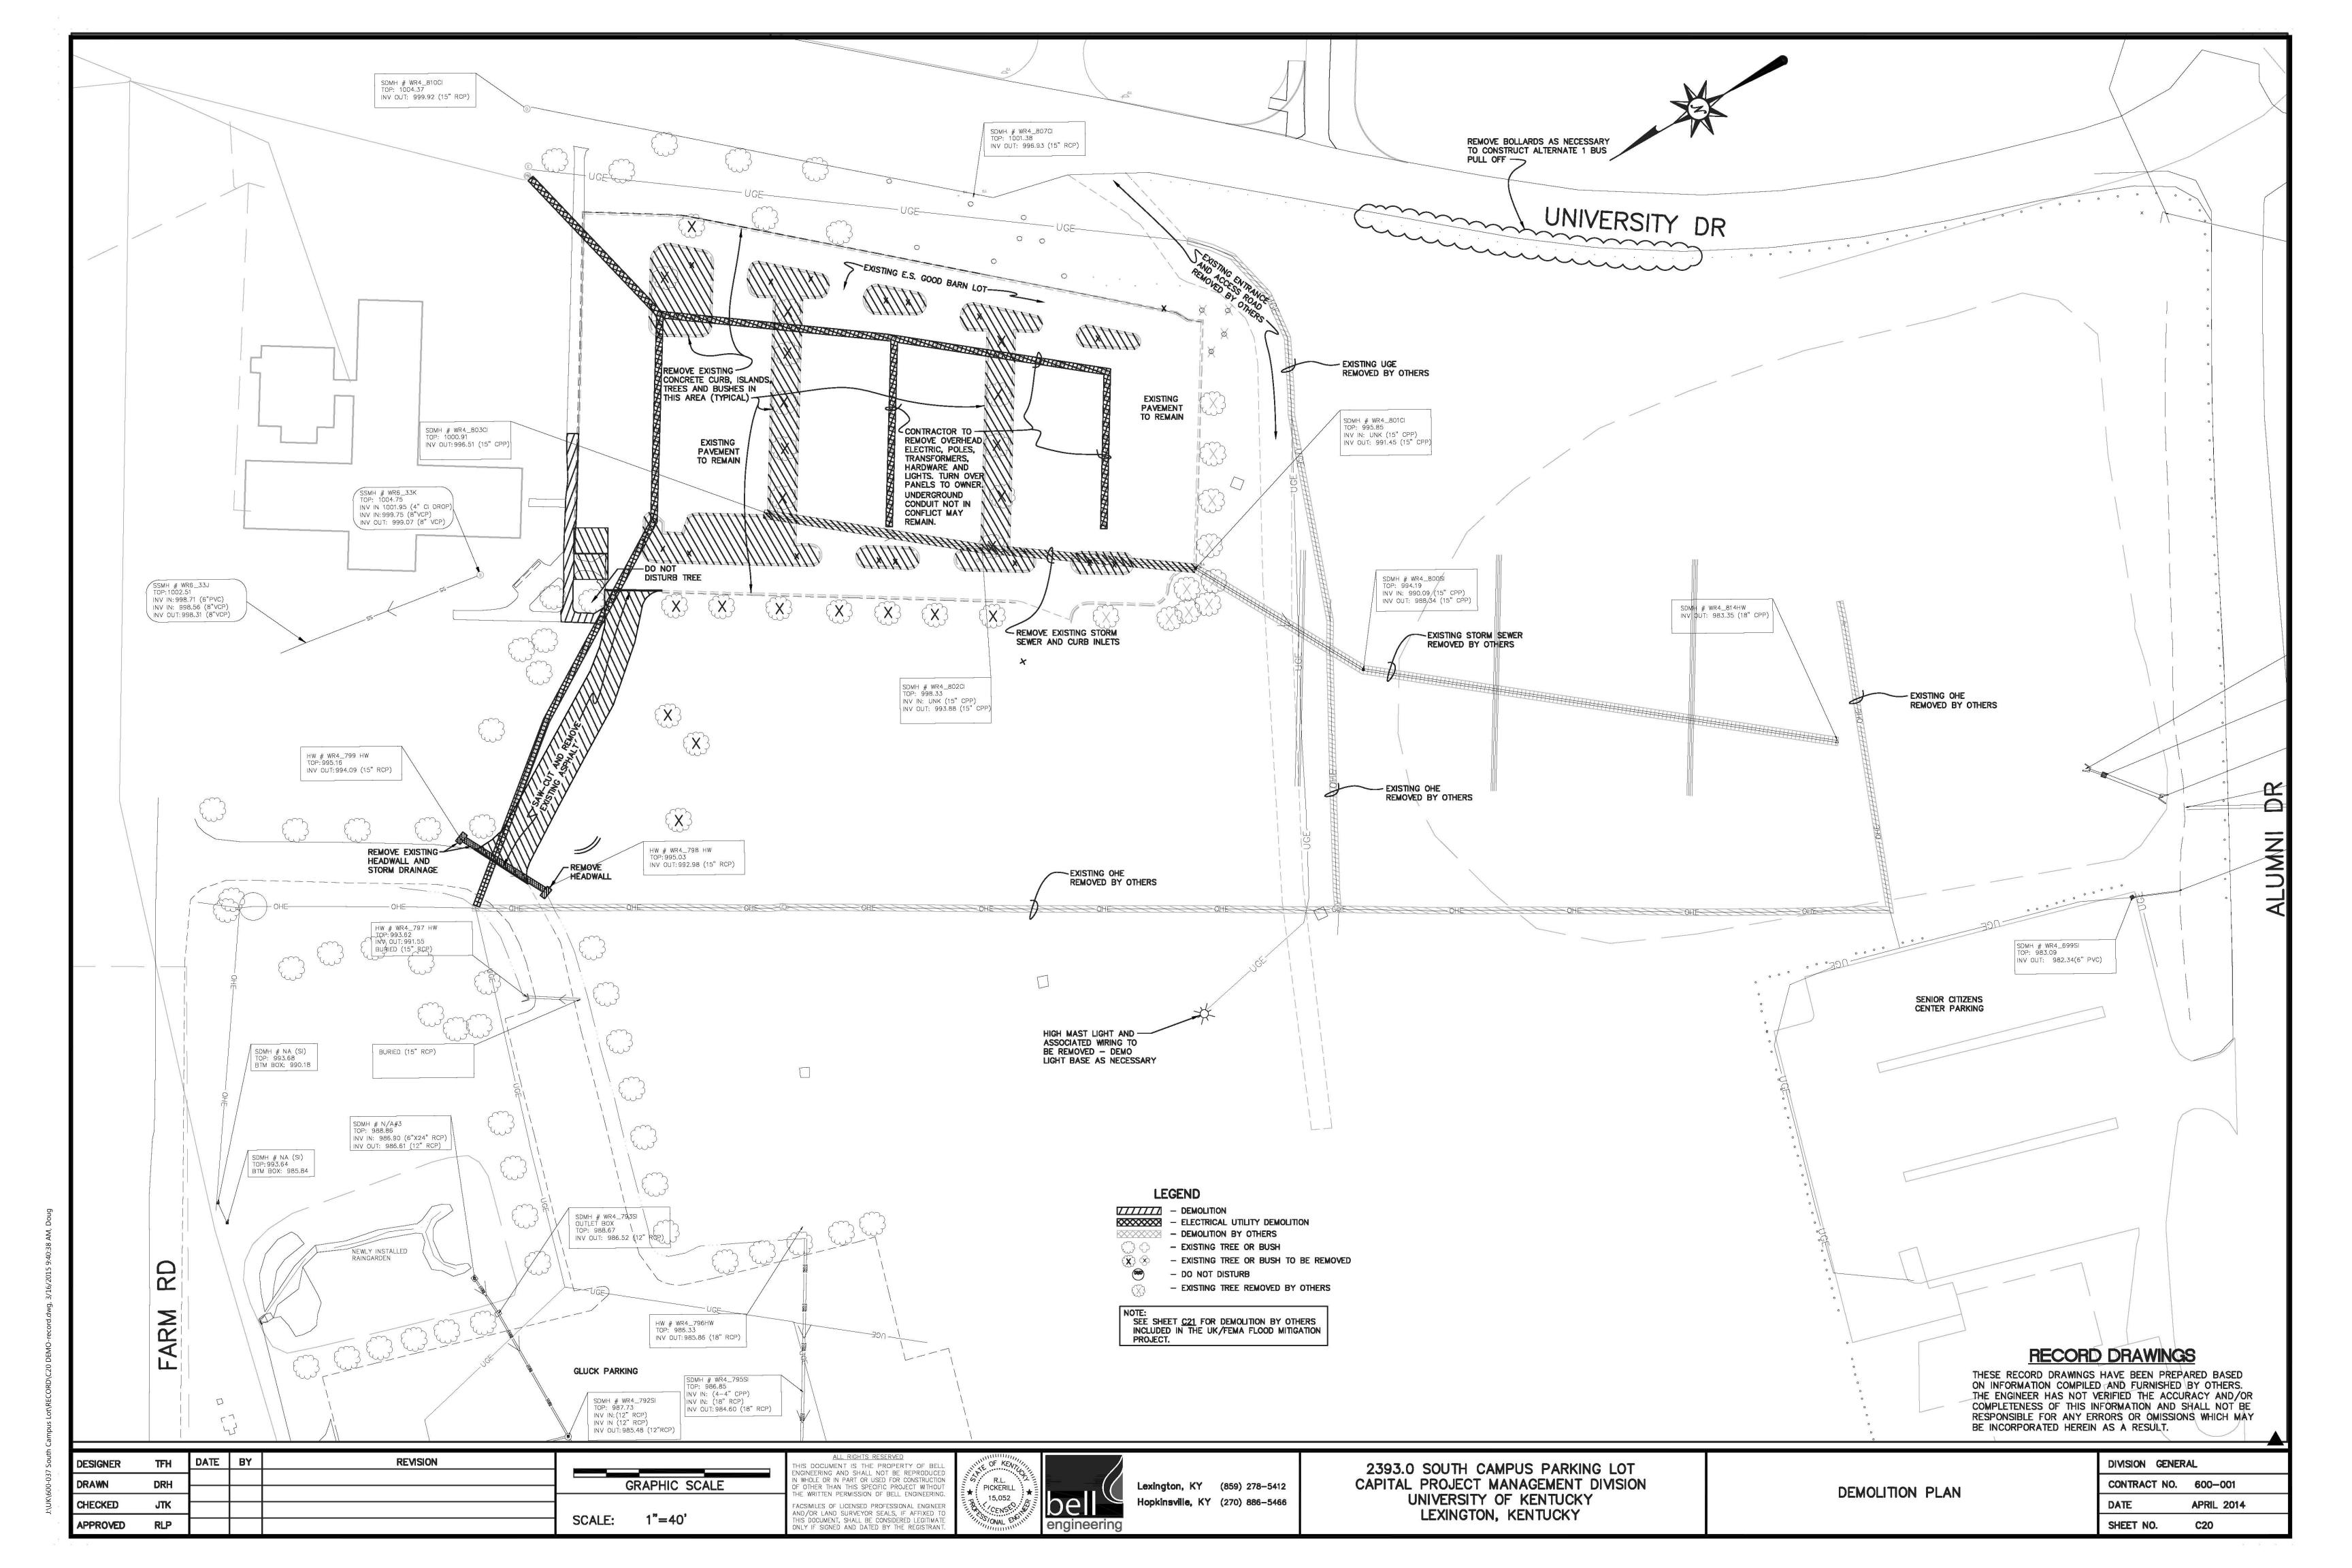

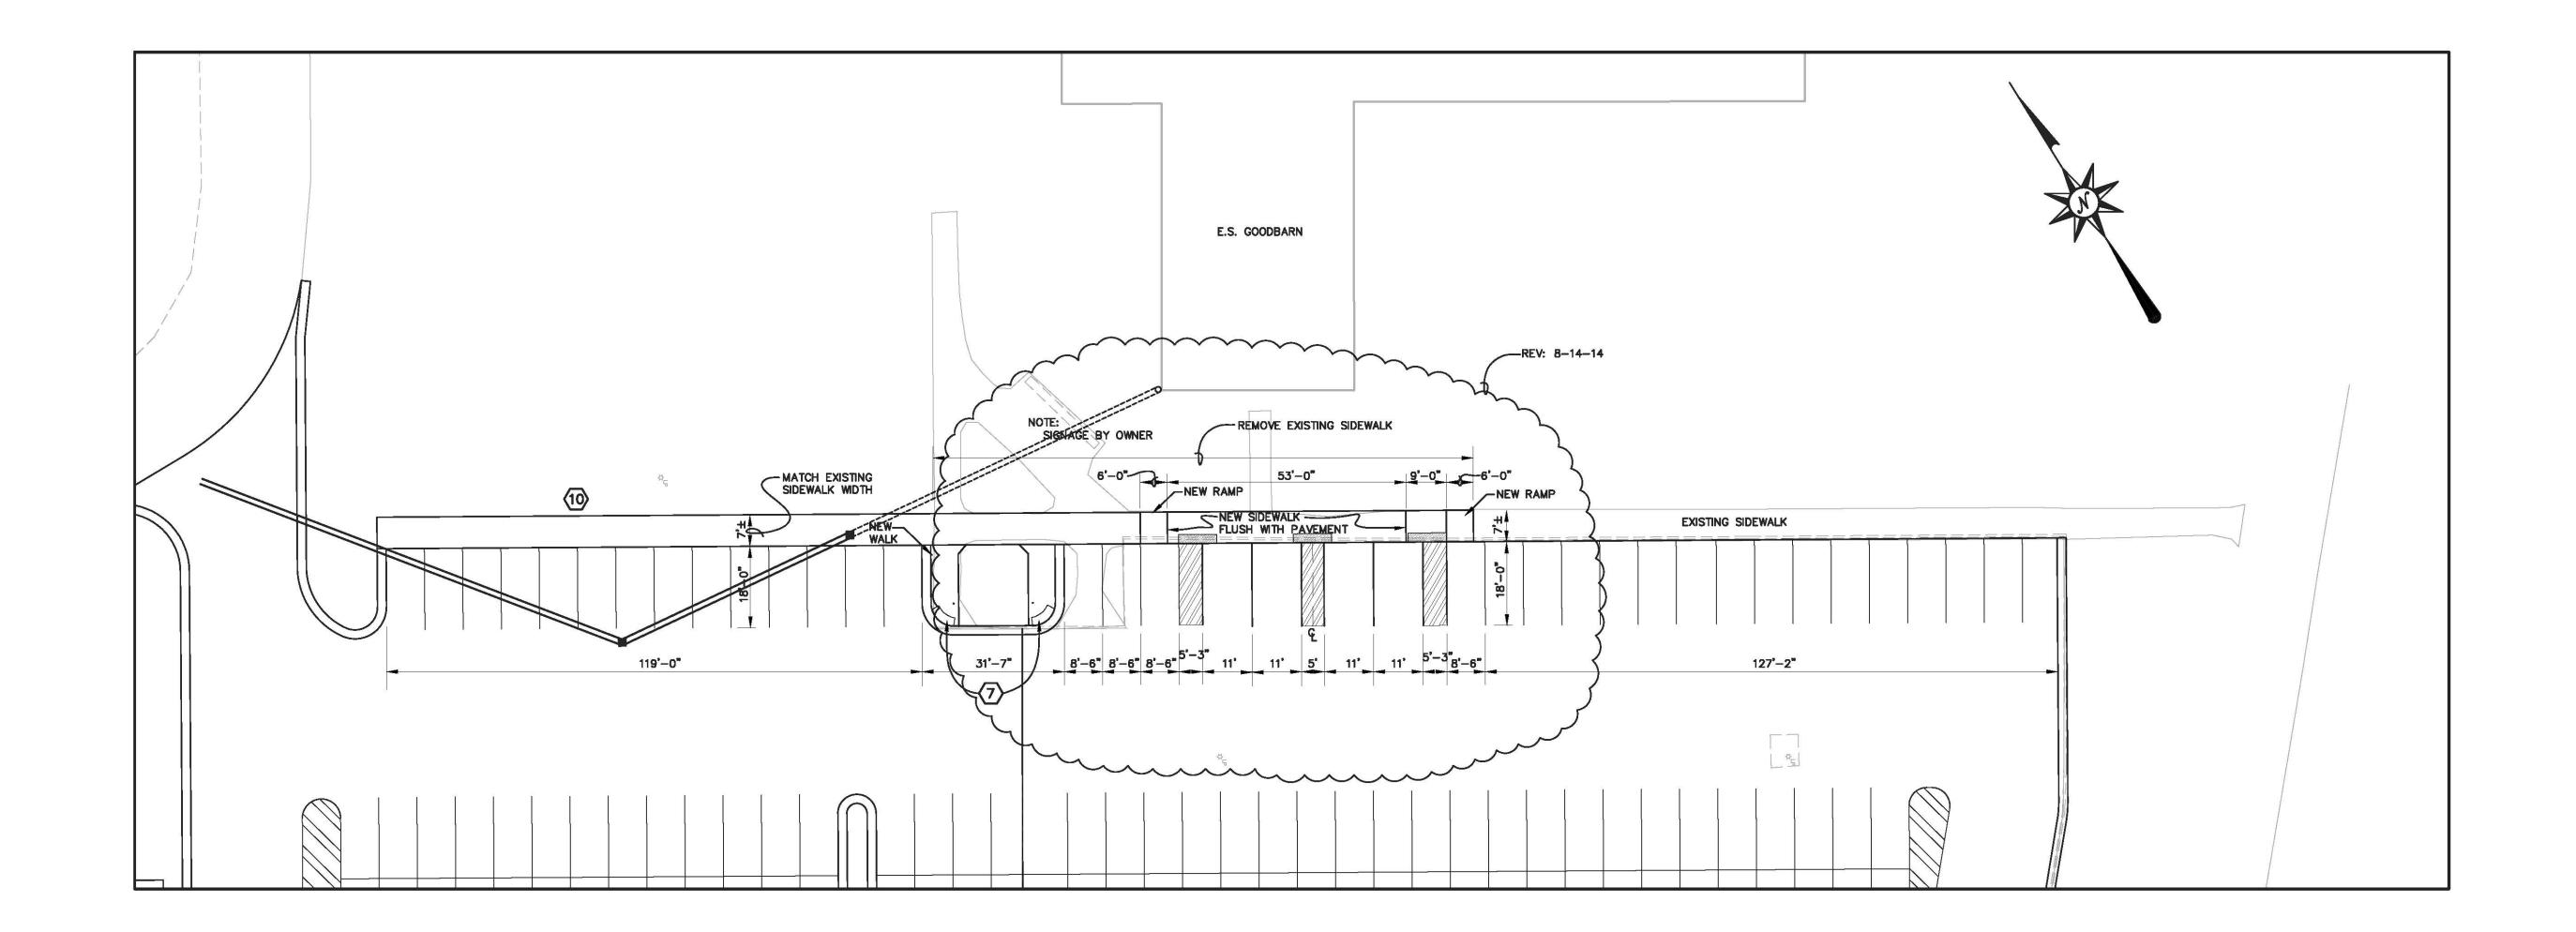

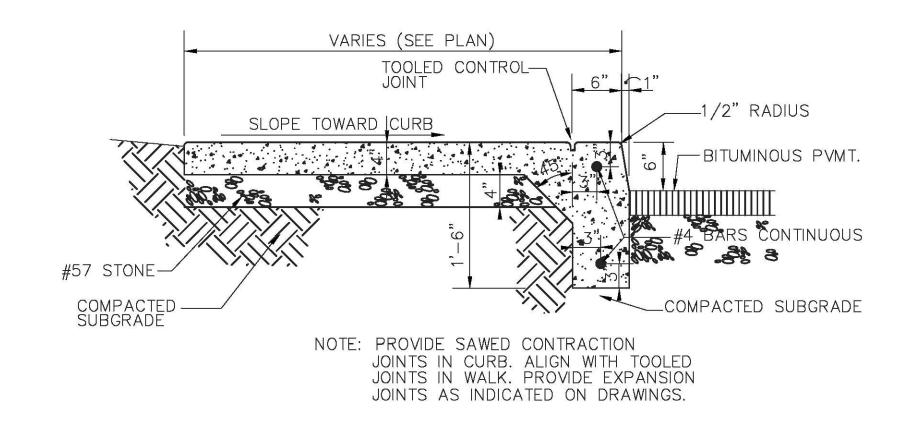

WALK WITH INTEGRAL CURB

RECORD DRAWINGS

THESE RECORD DRAWINGS HAVE BEEN PREPARED BASED ON INFORMATION COMPILED AND FURNISHED BY OTHERS. THE ENGINEER HAS NOT VERIFIED THE ACCURACY AND/OR COMPLETENESS OF THIS INFORMATION AND SHALL NOT BE RESPONSIBLE FOR ANY ERRORS OR OMISSIONS WHICH MAY BE INCORPORATED HEREIN AS A RESULT.

ADDENDUM NO. 1

DESIGNER TFH DATE BY REVISION

DRAWN DRH

CHECKED JTK

APPROVED RLP

DATE BY REVISION

REVISION

REVISION

REVISION


GRAPHIC SCALE

SCALE: 1"=20'

ALL RIGHTS RESERVED

THIS DOCUMENT IS THE PROPERTY OF BELL ENGINEERING AND SHALL NOT BE REPRODUCED IN WHOLE OR IN PART OR USED FOR CONSTRUCTION OF OTHER THAN THIS SPECIFIC PROJECT WITHOUT THE WRITTEN PERMISSION OF BELL ENGINEERING.

FACSIMILES OF LICENSED PROFESSIONAL ENGINEER AND/OR LAND SURVEYOR SEALS, IF AFFIXED TO THIS DOCUMENT, SHALL BE CONSIDERED LEGITMATE ONLY IF SIGNED AND DATED BY THE REGISTRANT.

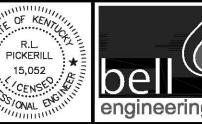



Lexington, KY (859) 278-5412
Hopkinsville, KY (270) 886-5466

2393.0 SOUTH CAMPUS PARKING LOT CAPITAL PROJECT MANAGEMENT DIVISION UNIVERSITY OF KENTUCKY LEXINGTON, KENTUCKY

HANDICAP SIDEWALK/RAMP & PARKING LAYOUT

DIVISION GE	NERAL
CONTRACT NO.	600-001
DATE	APRIL 2014
SHEET NO.	C30.1

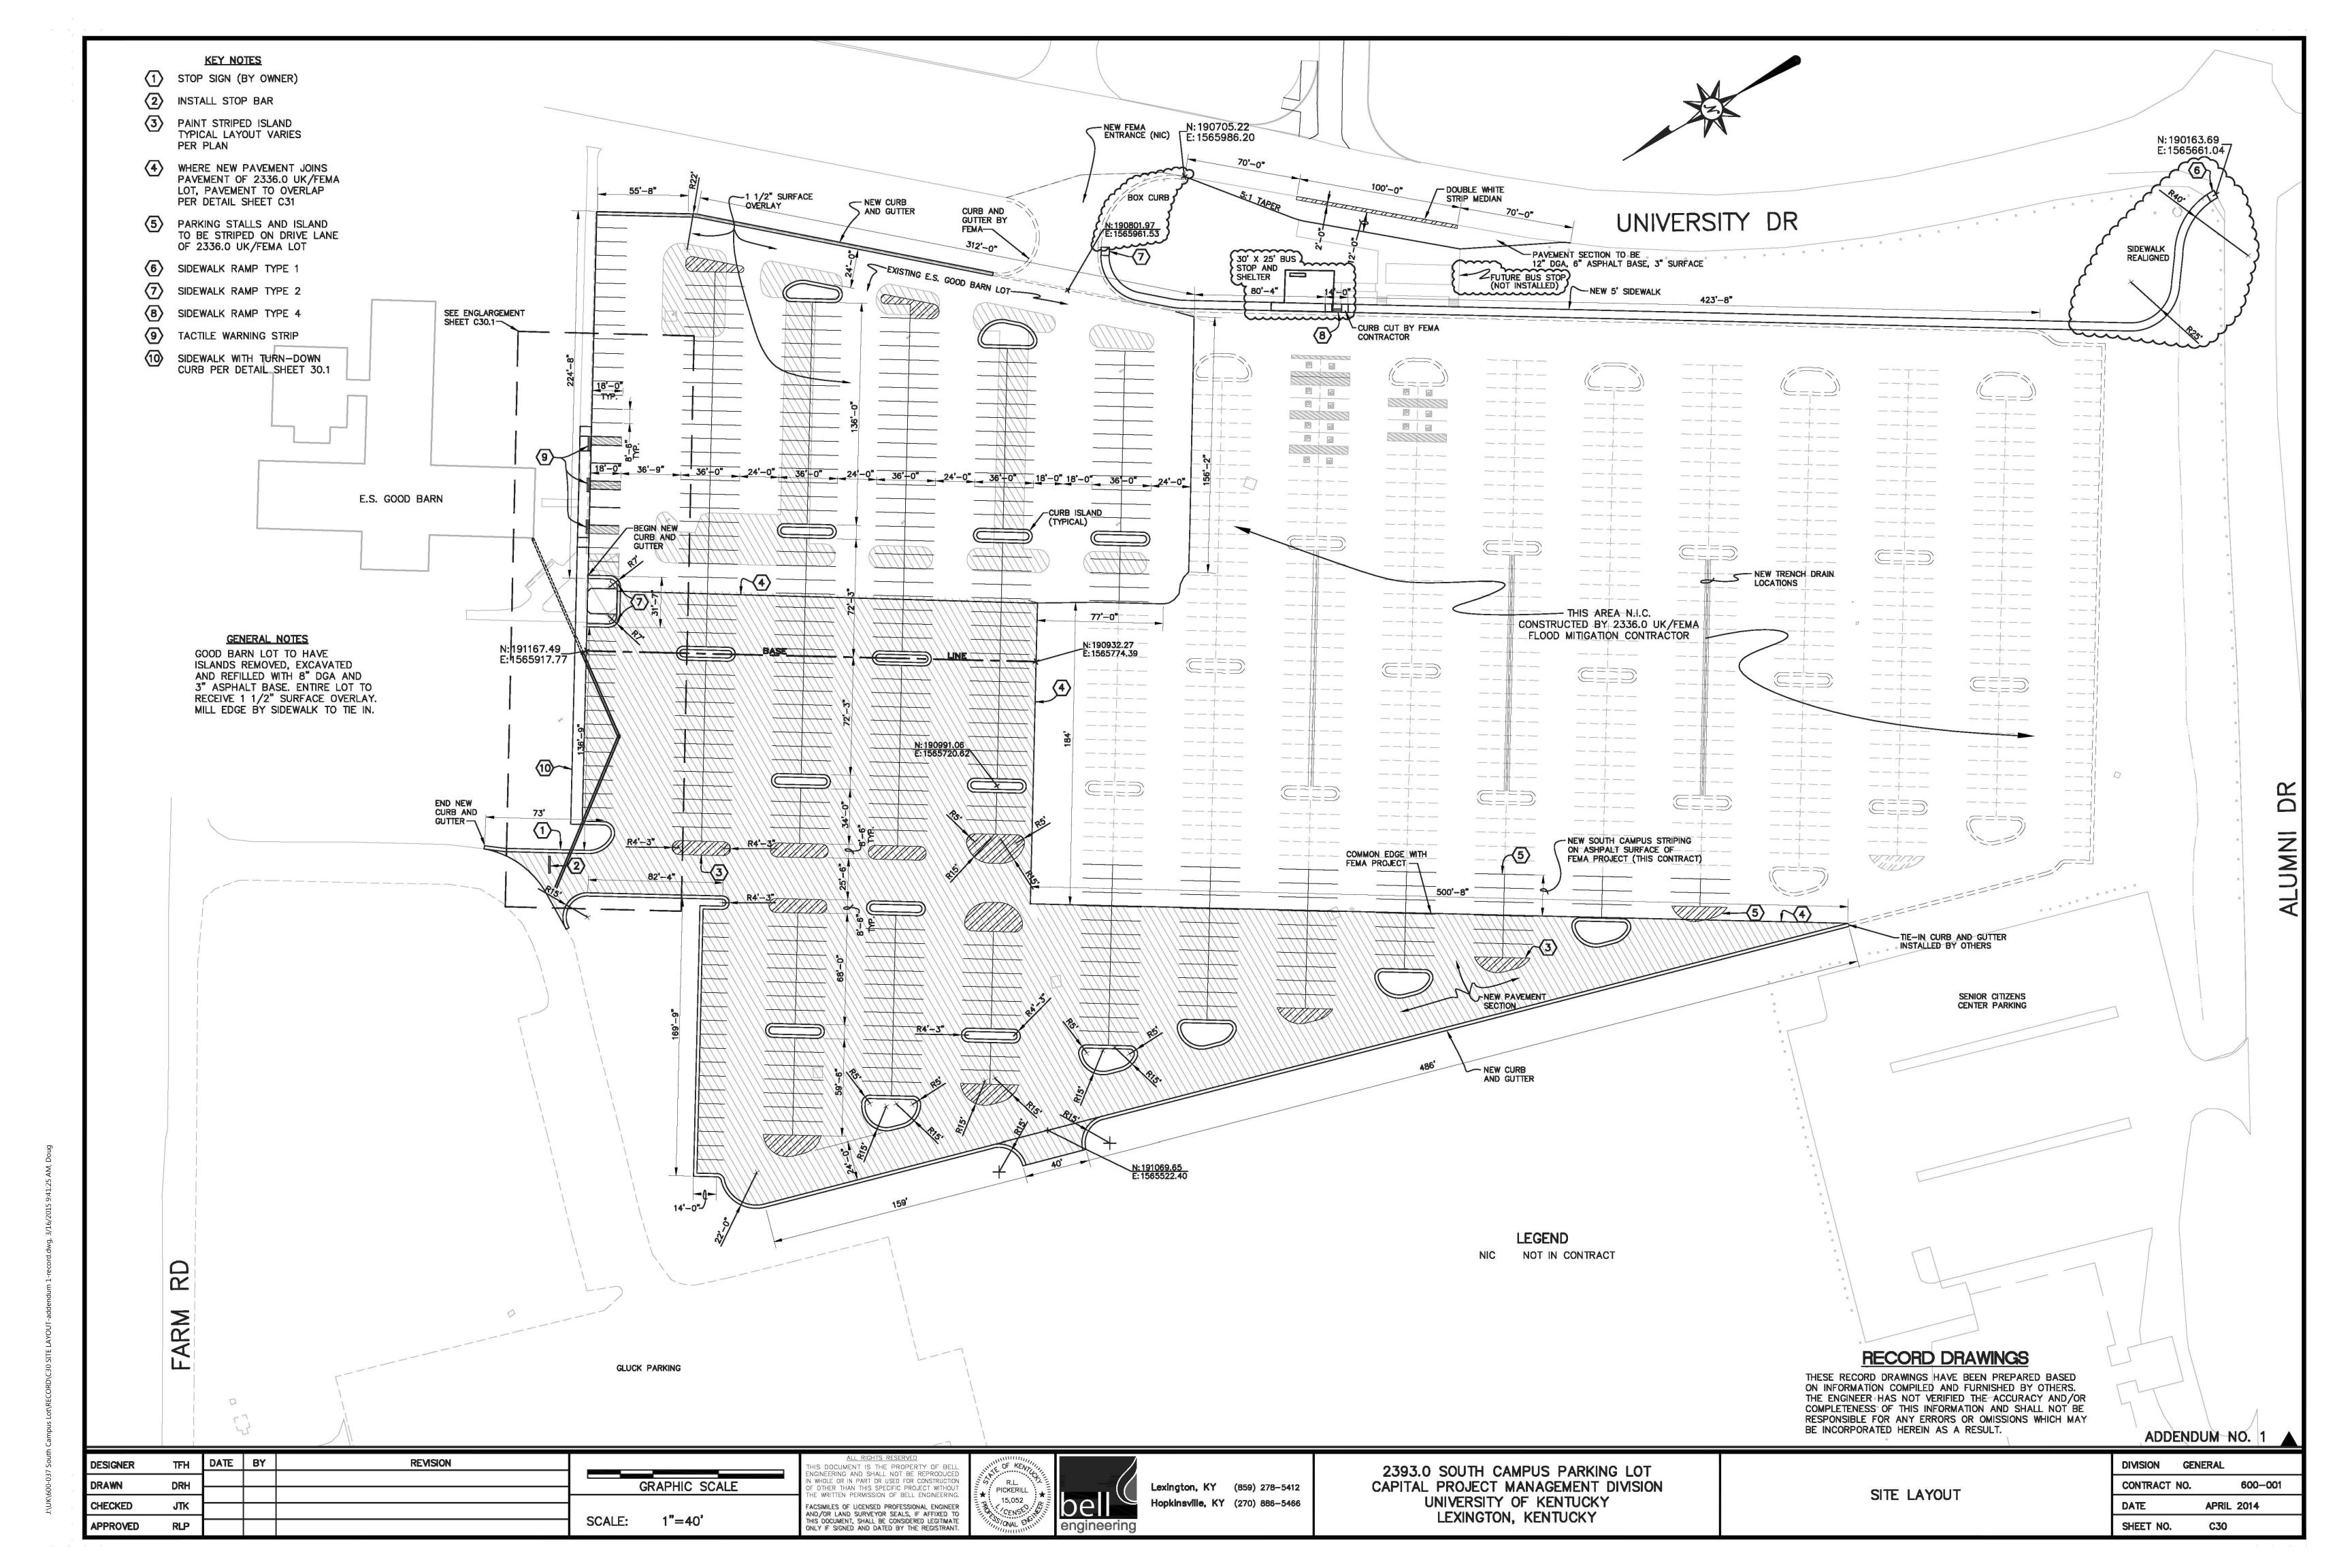

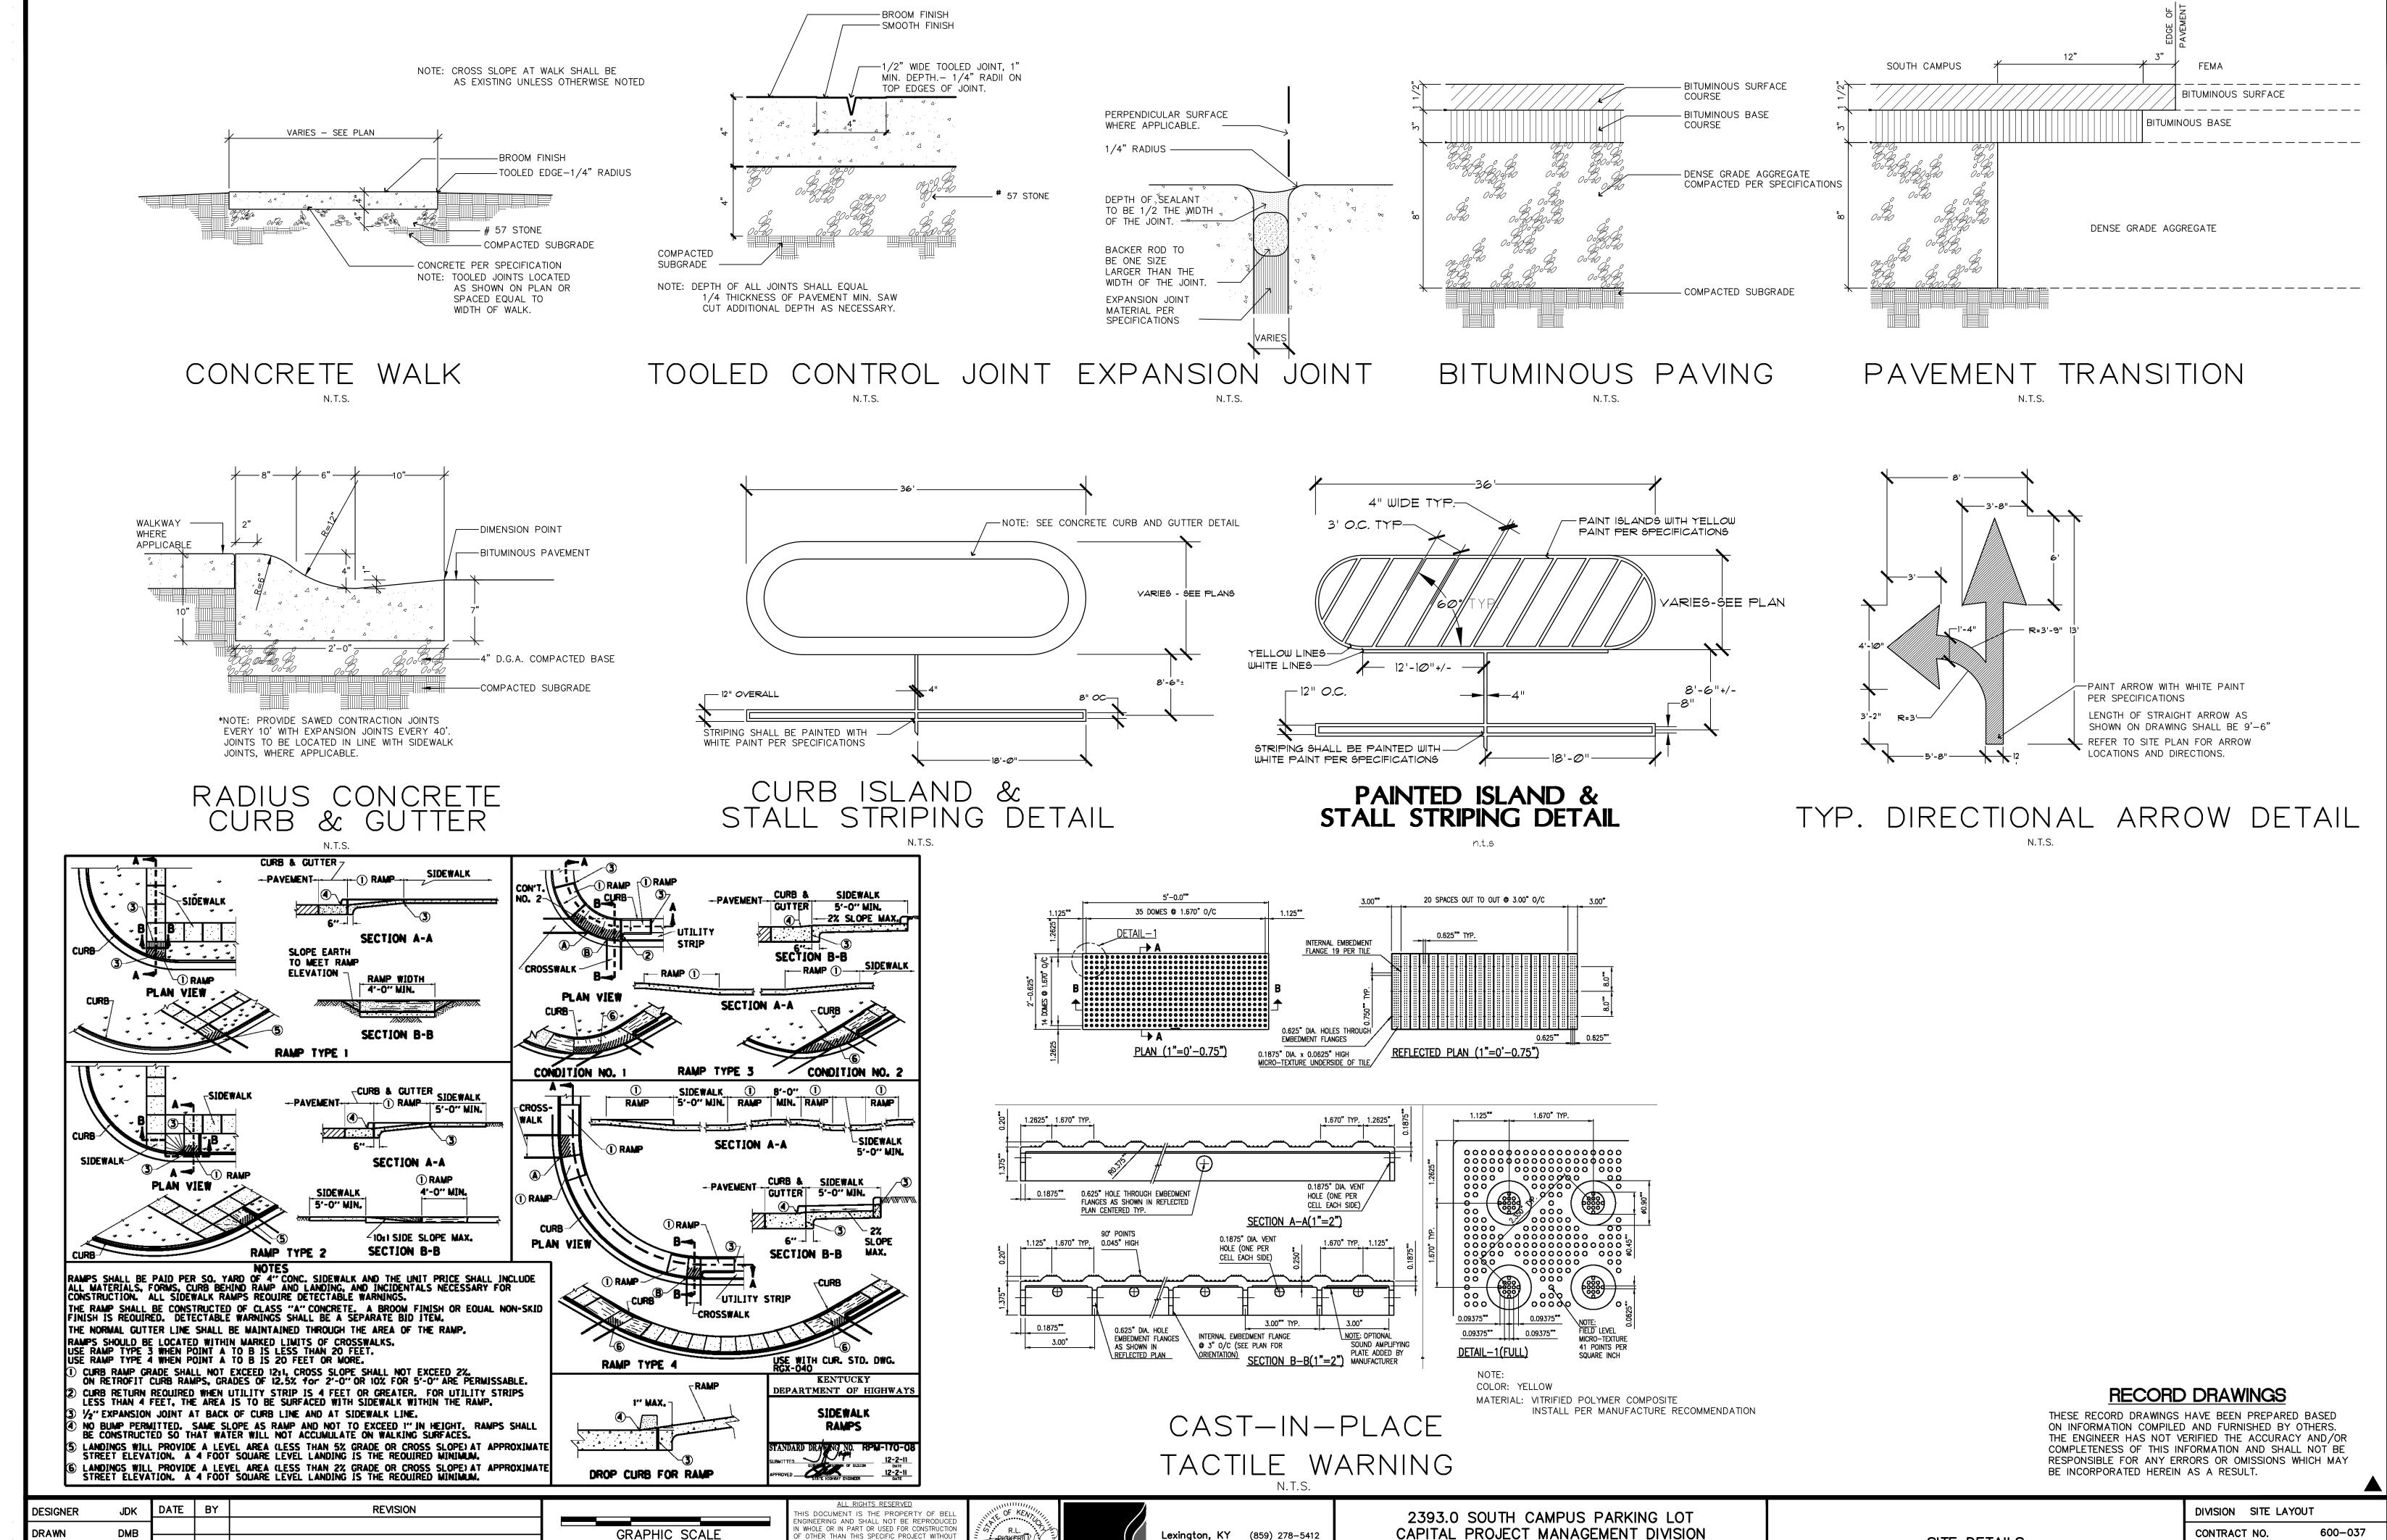

Hopkinsville, KY (270) 886-5466

UNIVERSITY OF KENTUCKY

LEXINGTON, KENTUCKY

= 50052e

WRITTEN PERMISSION OF BELL ENGINEERING

ACSIMILES OF LICENSED PROFESSIONAL ENGINEER

AND/OR LAND SURVEYOR SEALS, IF AFFIXED TO THIS DOCUMENT, SHALL BE CONSIDERED LEGITIMATE

SCALE: AS NOTED

AGC


CHECKED


APPROVED


SITE DETAILS


CONTRACT NO. 600
DATE APRIL 2014


SHEET NO. C31

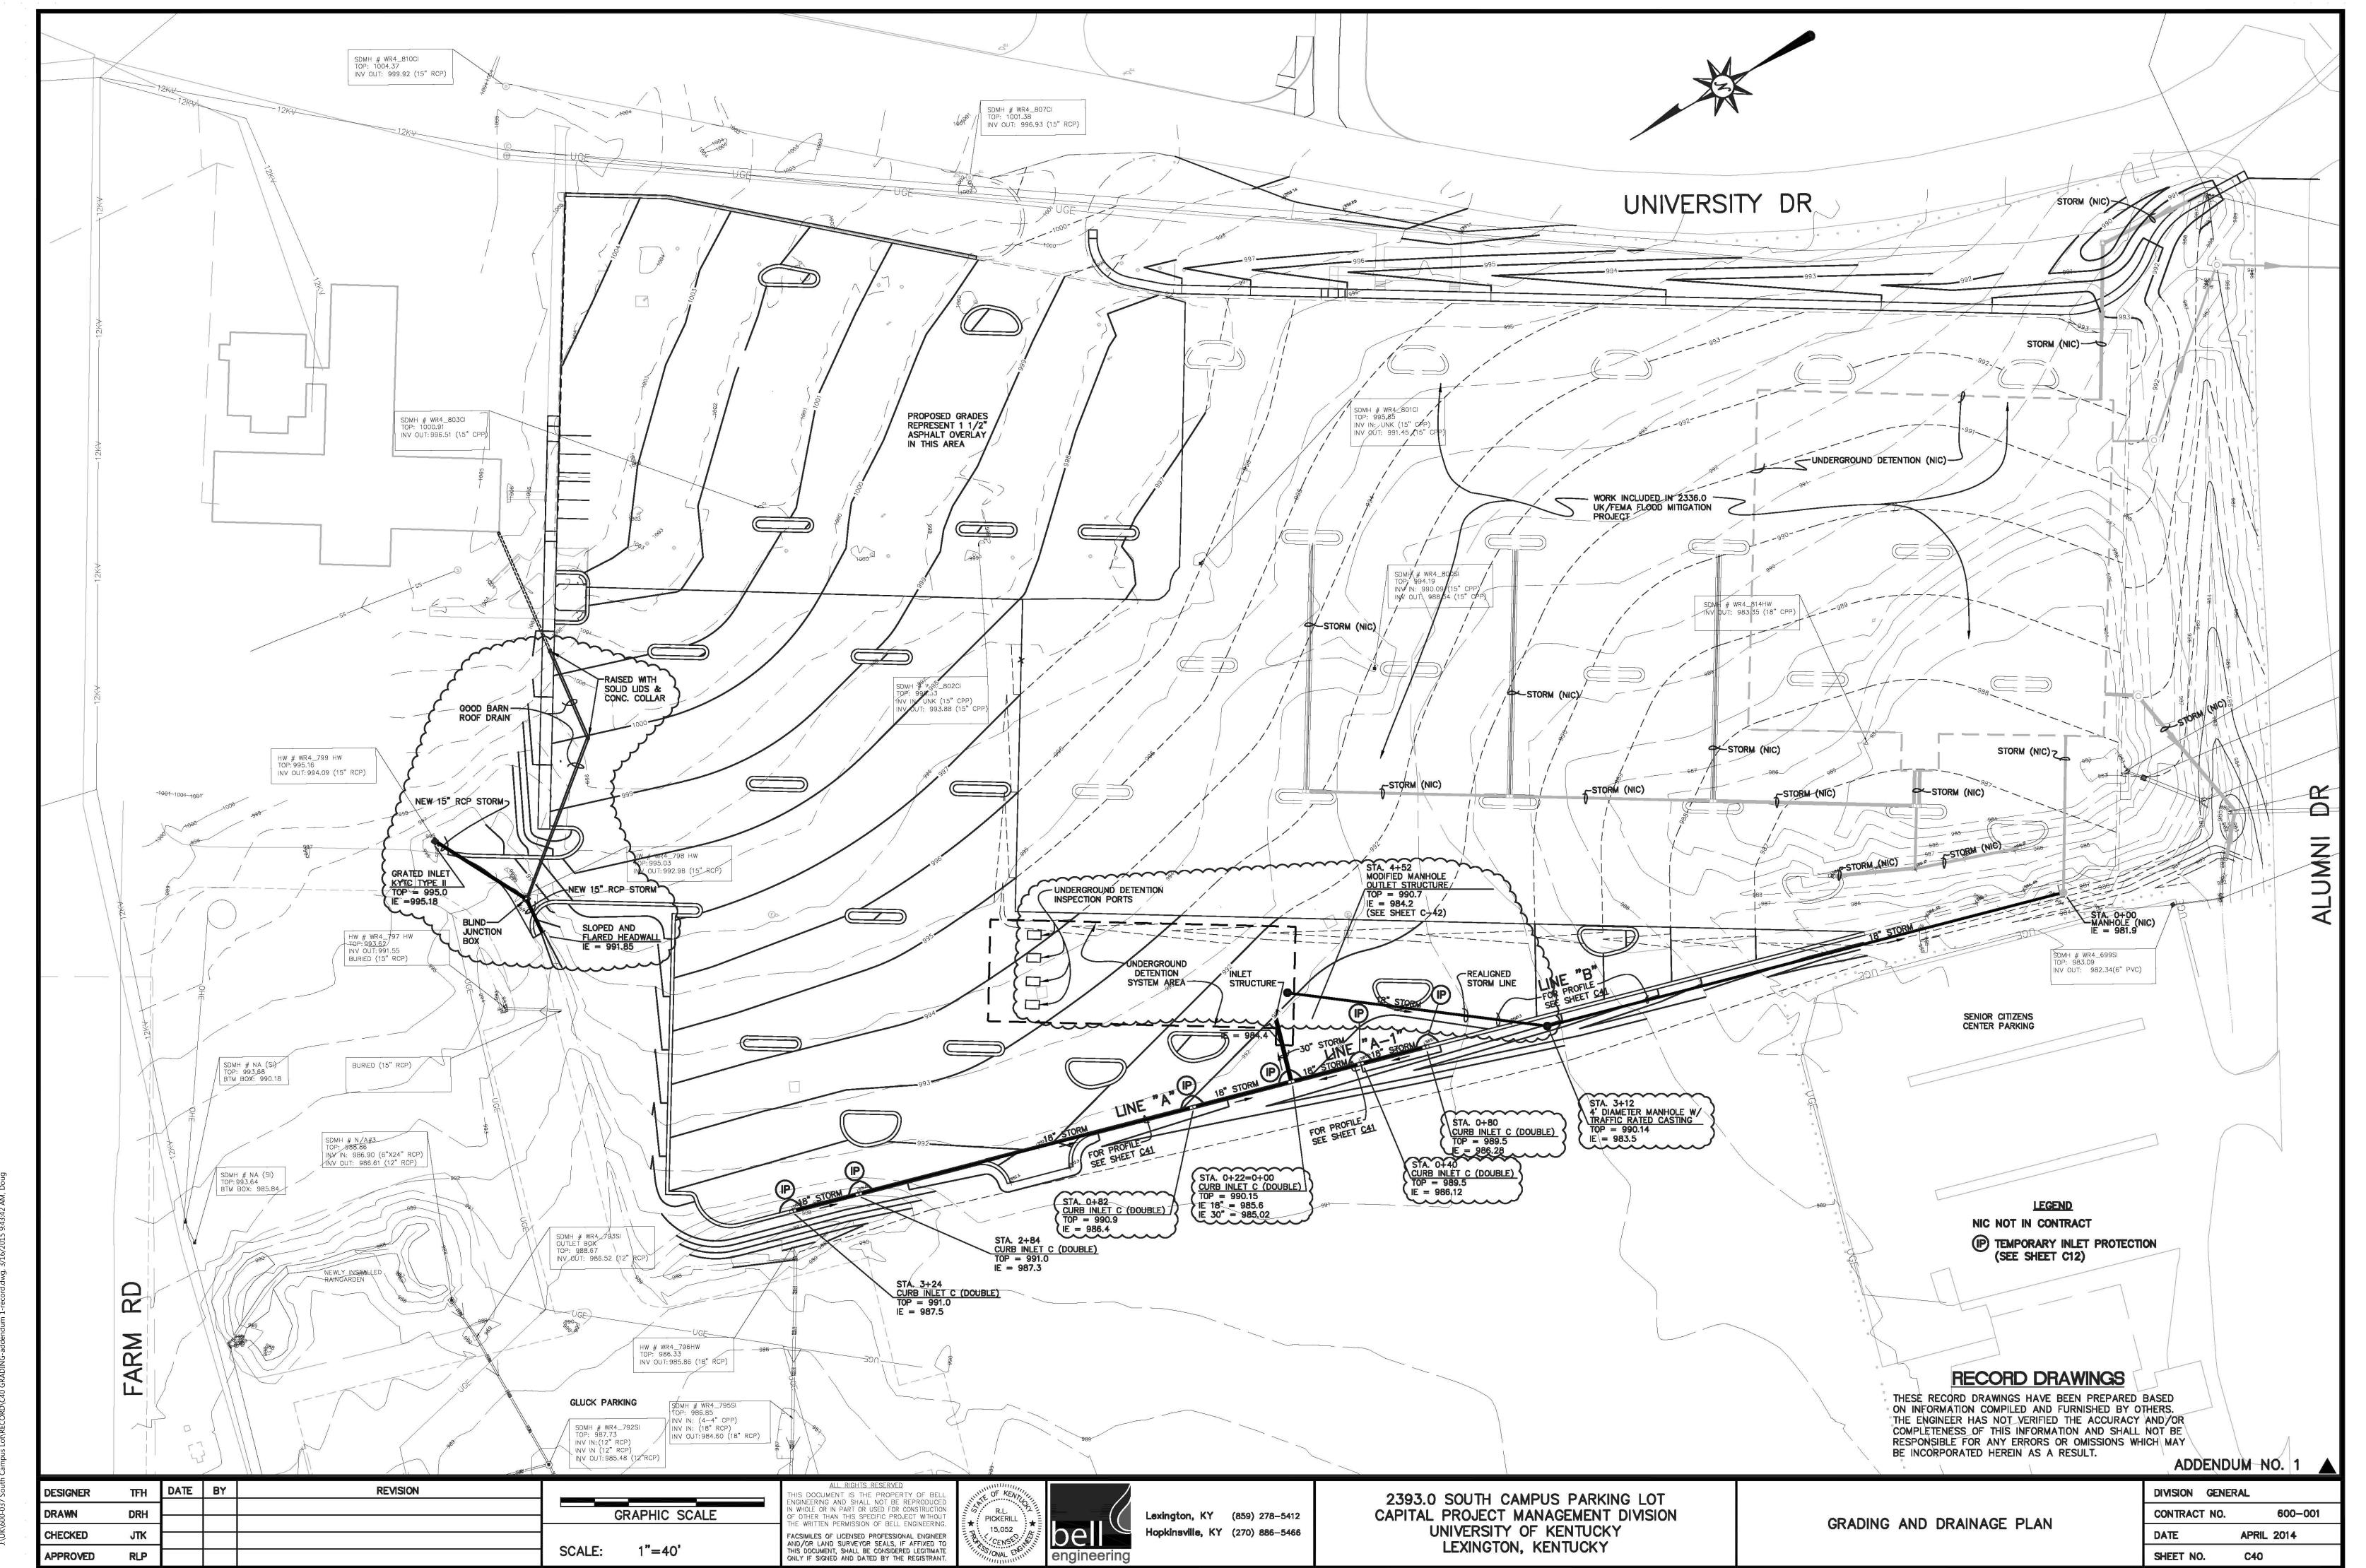

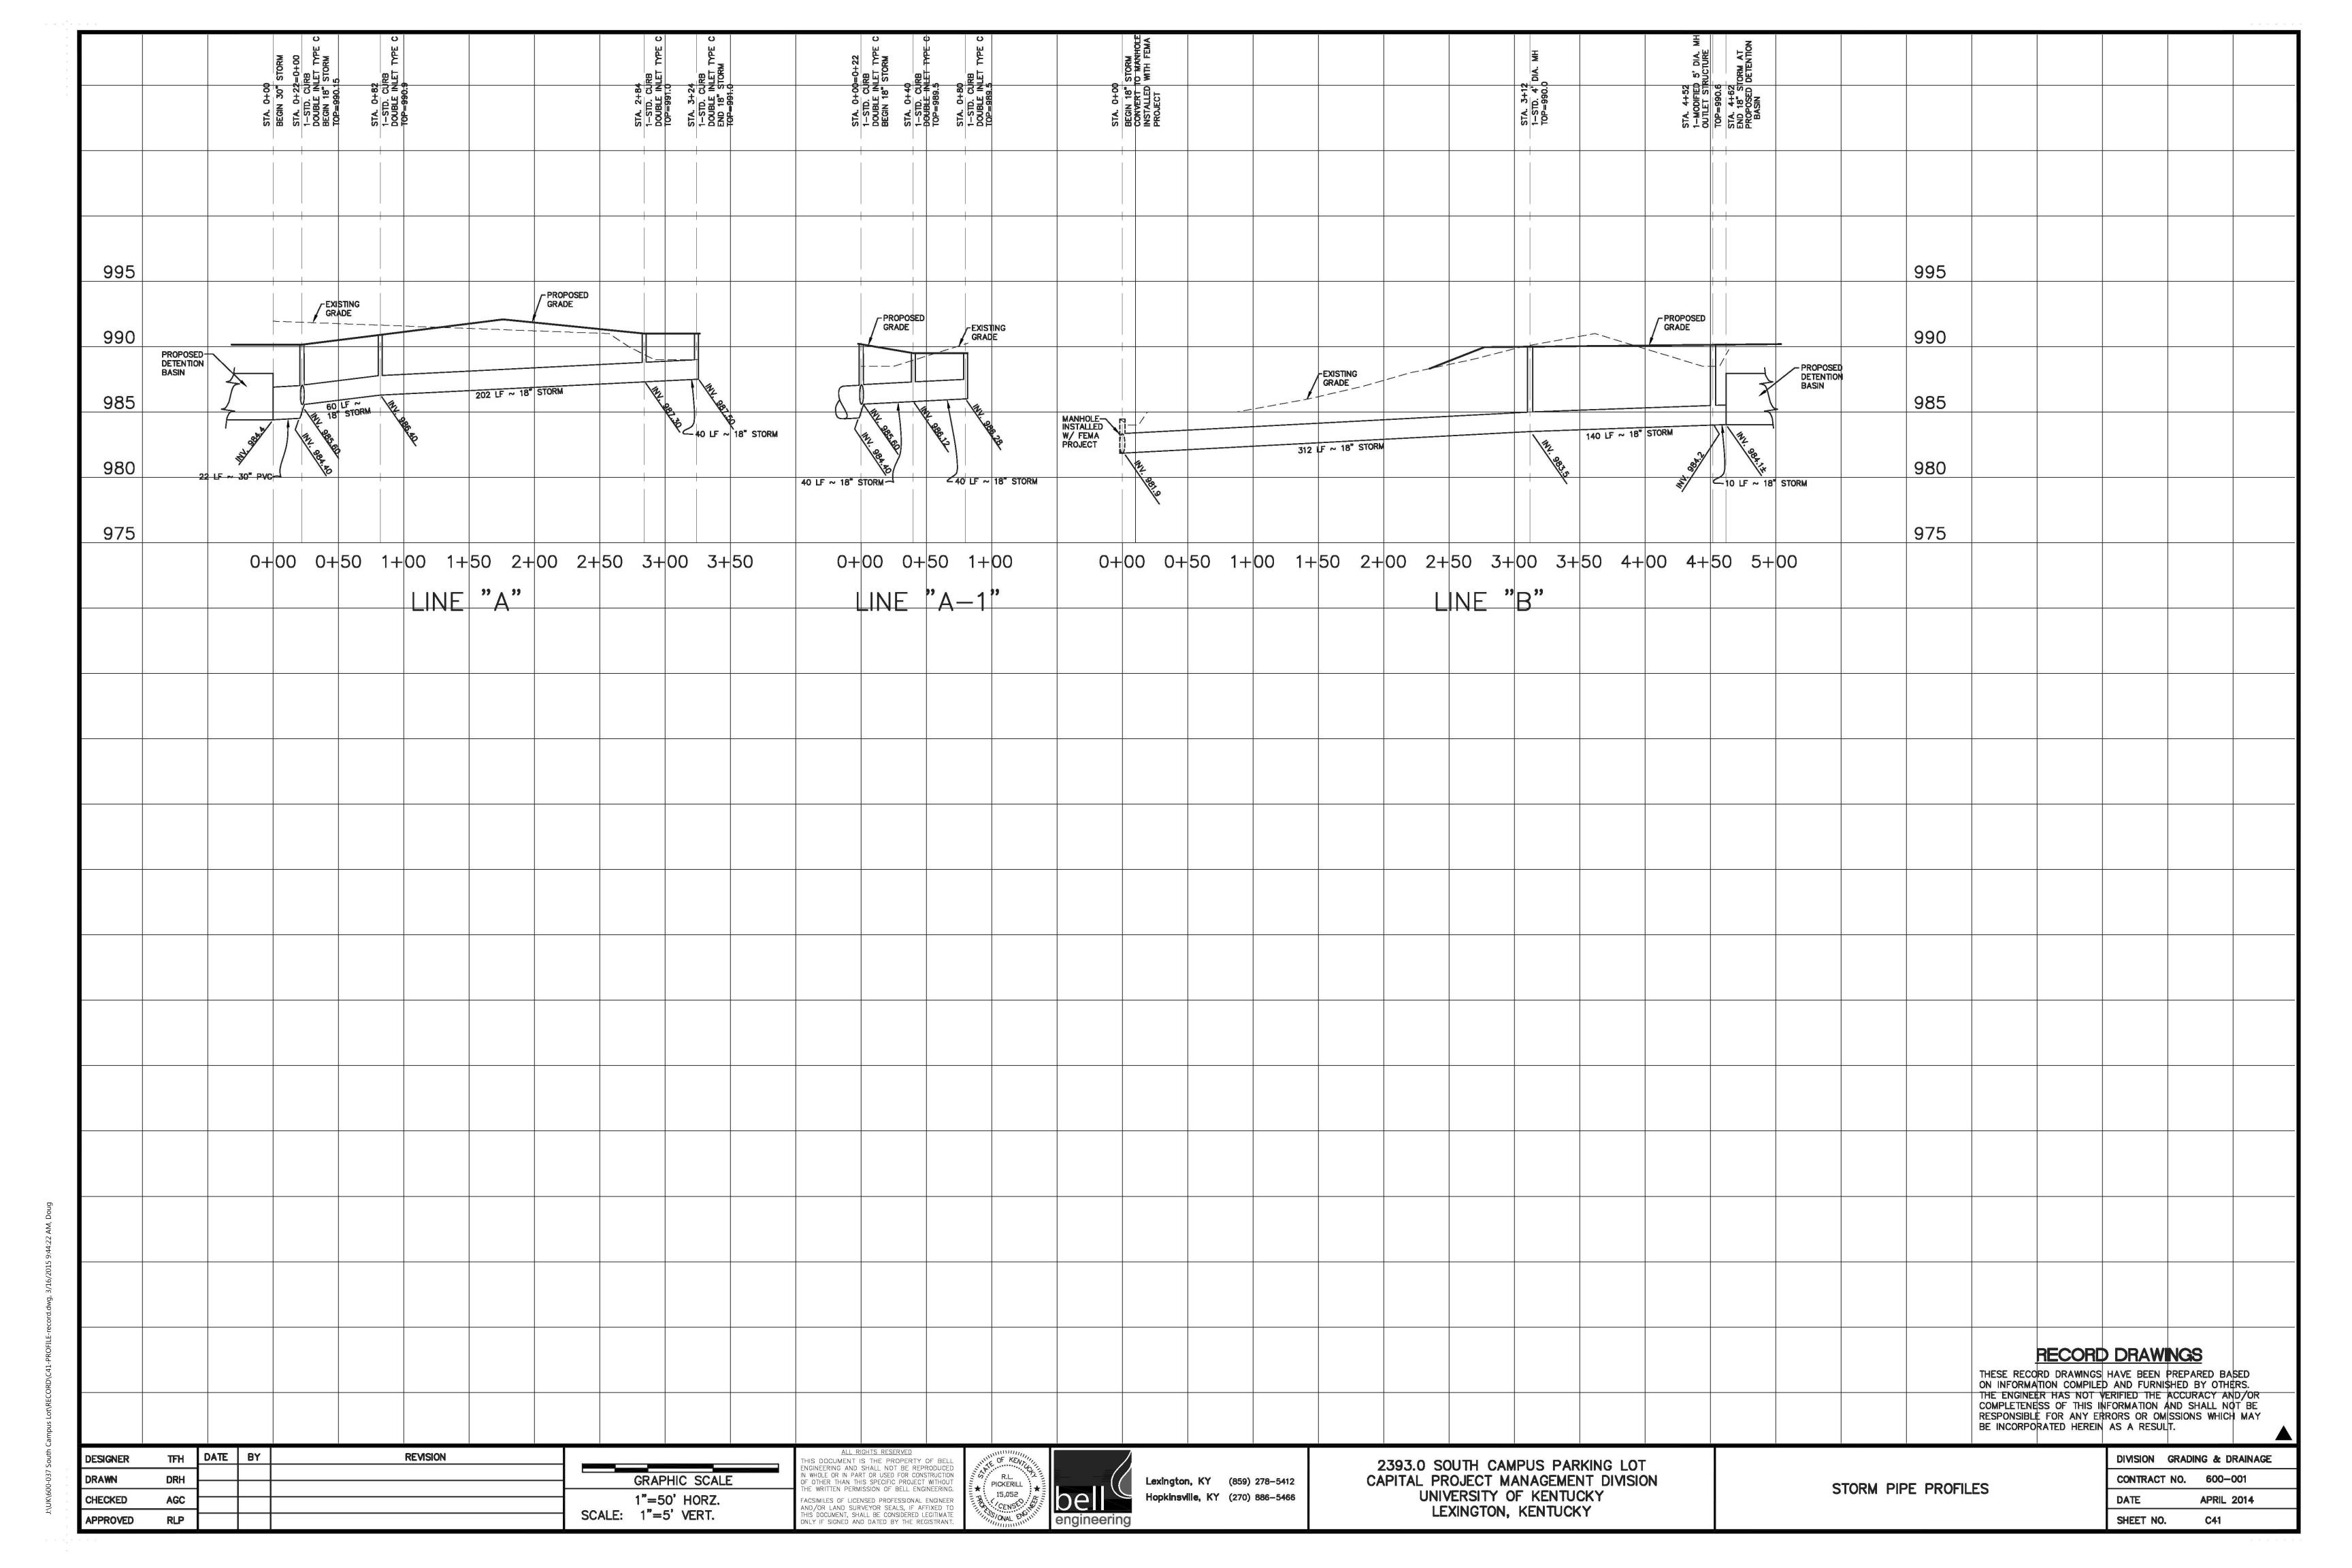


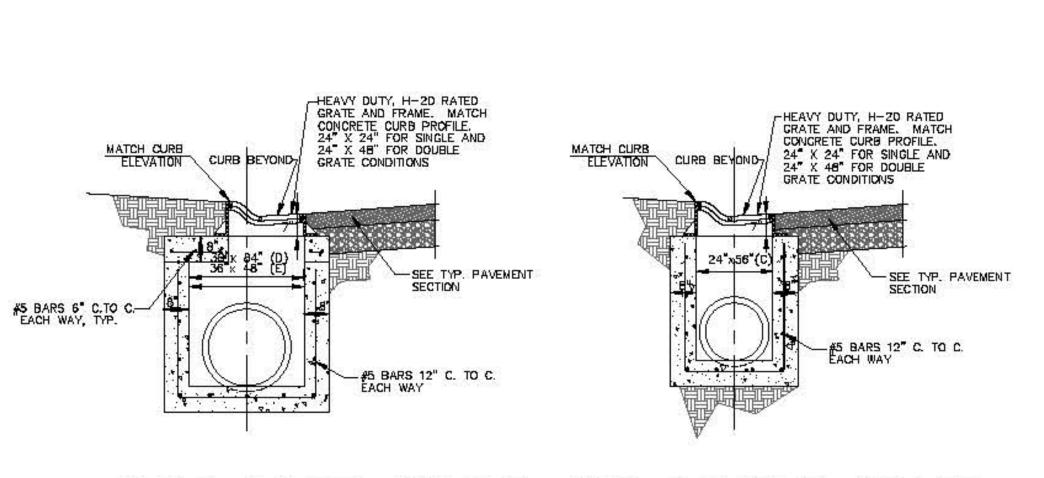


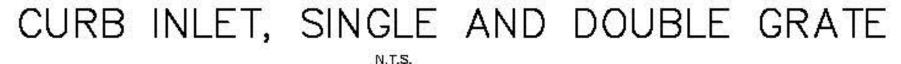

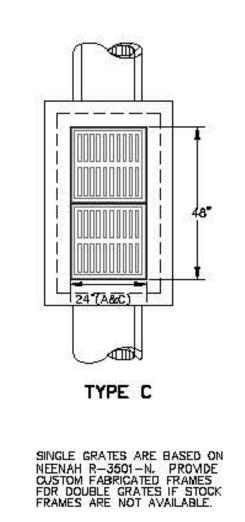

CURB INLET - DOUBLE GRATE

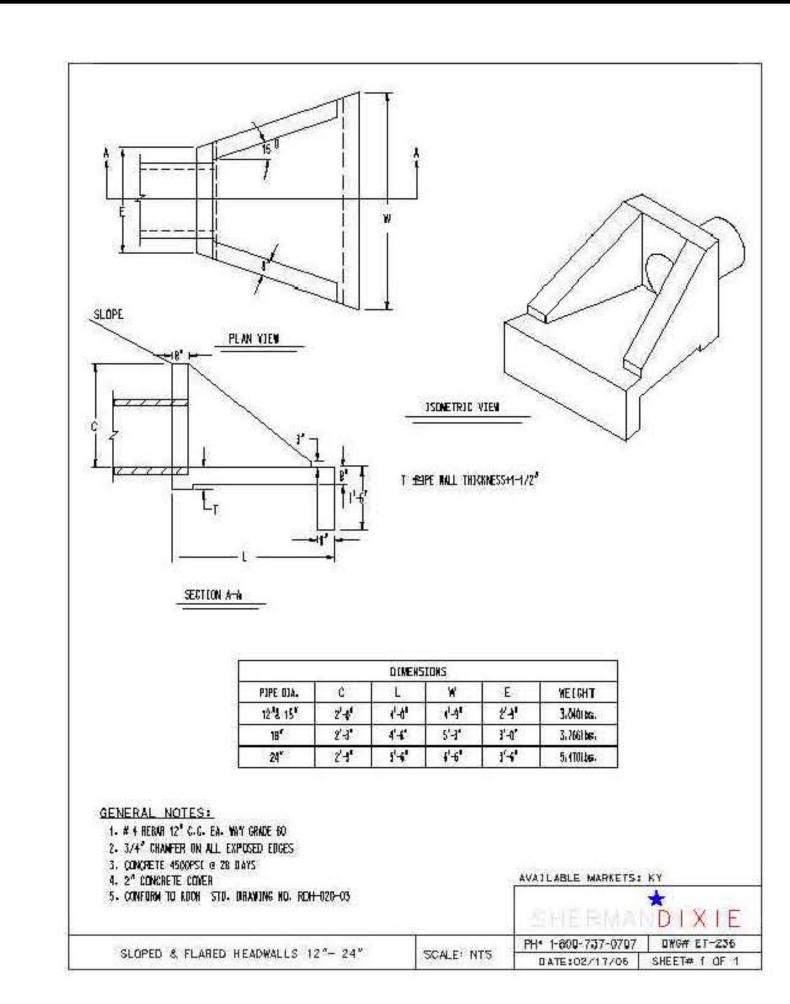

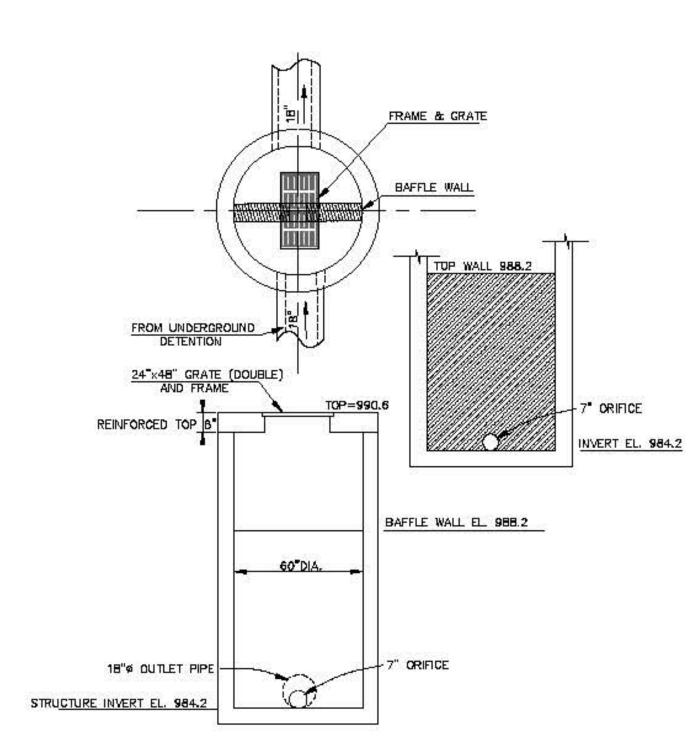

MODIFIED MANHOLE OUTLET STRUCTURE

RECORD DRAWINGS


THESE RECORD DRAWINGS HAVE BEEN PREPARED BASED ON INFORMATION COMPILED AND FURNISHED BY OTHERS. THE ENGINEER HAS NOT VERIFIED THE ACCURACY AND/OR COMPLETENESS OF THIS INFORMATION AND SHALL NOT BE RESPONSIBLE FOR ANY ERRORS OR OMISSIONS WHICH MAY BE INCORPORATED HEREIN AS A RESULT.

DESIGNER	TFH	DATE	BY	REVISION	·		, ,
DRAWN	DRH			<u> </u>	9	GRAPHIC SCALE	, D
CHECKED	AGC						F
APPROVED	RLP				SCALE:	AS NOTED	Î

ALL RIGHTS RESERVED

THIS DOCUMENT IS THE PROPERTY OF BELL
ENGINEERING AND SHALL NOT BE REPRODUCED
IN WHOLE OR IN PART OR USED FOR CONSTRUCTION
OF OTHER THAN THIS SPECIFIC PROJECT WITHOUT
THE WRITTEN PERMISSION OF BELL ENGINEERING.
FACSIMLES OF LICENSED PROFESSIONAL ENGINEER
AND/OR LAND SURVEYOR SCALS, IF AFFIXED TO
THIS DOCUMENT, SHALL BE CONSIDERED LEGITIMATE
ONLY IF SKRIED AND DATED BY THE REGISTRANT.




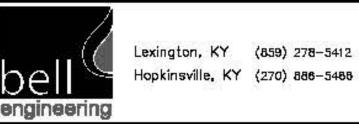

2393.0 SOUTH CAMPUS PARKING LOT CAPITAL PROJECT MANAGEMENT DIVISION UNIVERSITY OF KENTUCKY LEXINGTON, KENTUCKY

DRAINAGE STRUCTURE DETAILS

DIVISION	GRADING & DRAINAGE
CONTRACT	NO. 600-037
DATE	APRIL 2014
SHEET NO	. C42

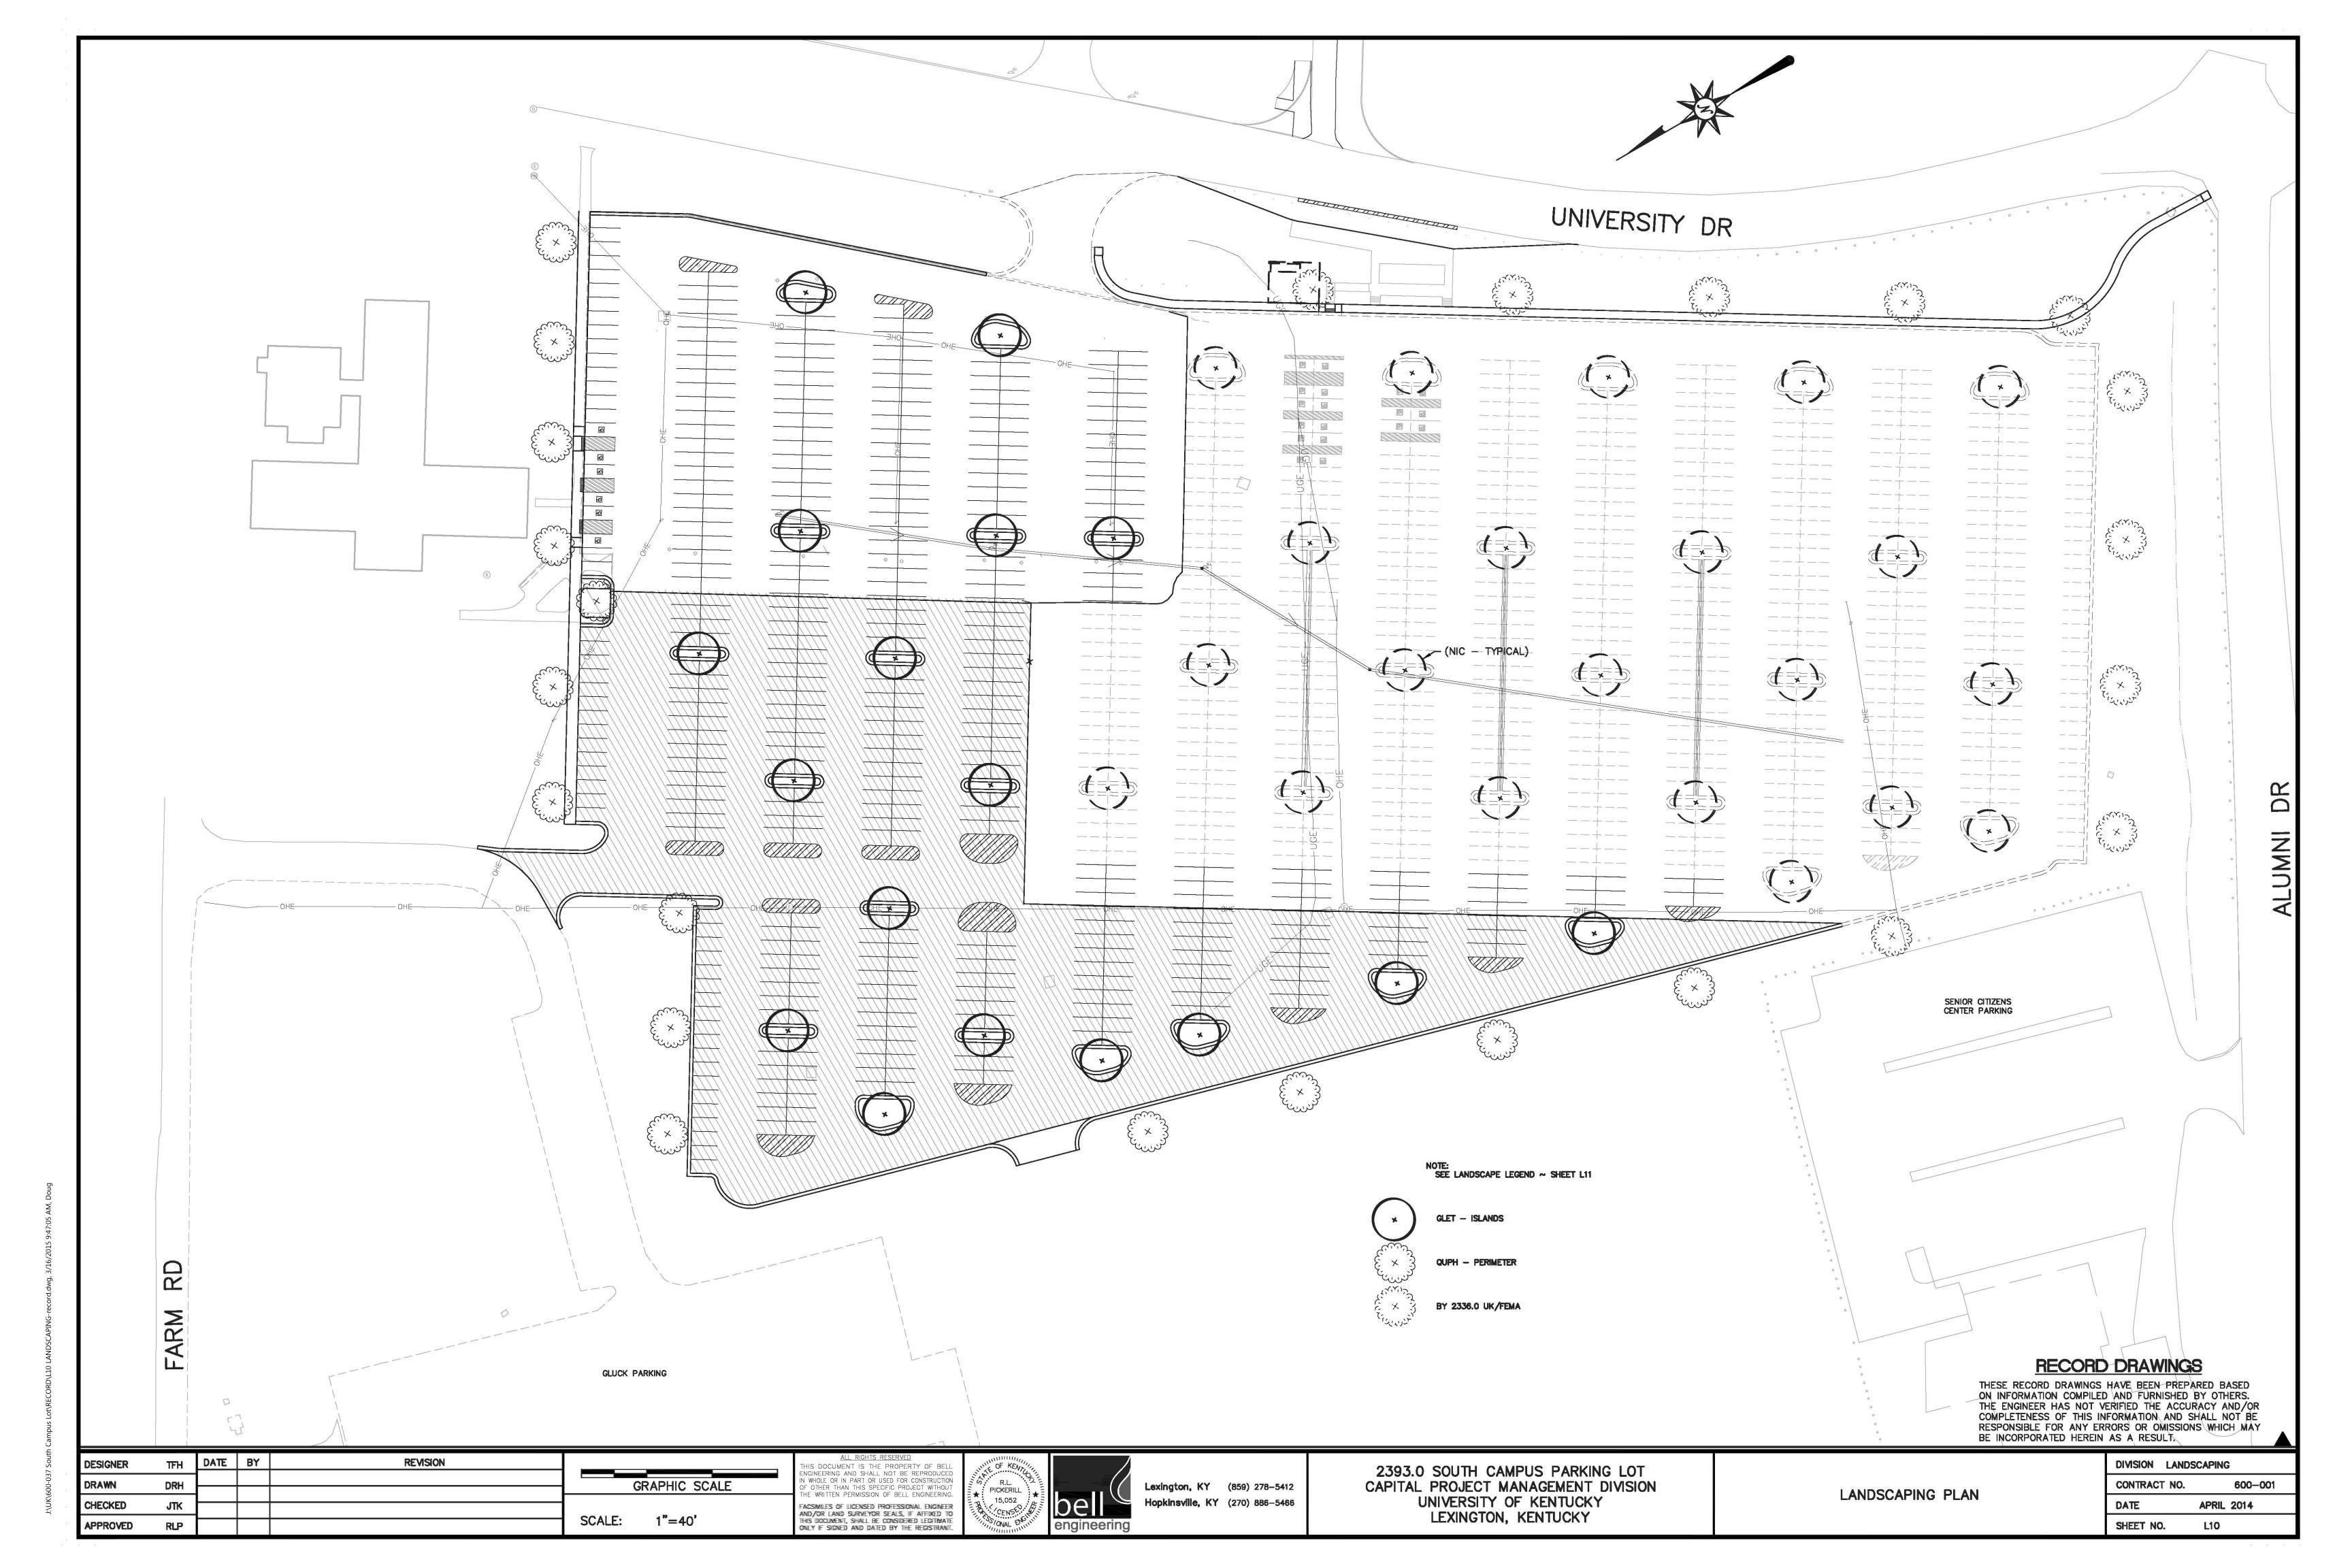


ABBREV.	BOTANICAL NAME	COMMON NAME	MINIMUM CALIPER	MINIMUM SPREAD	MINIMUM HEIGHT	MINIMUM BALL DIA.	NO.CANE	
GLET	Gleditsia triancanthos inermis 'Imperial'	Imperial Honeylocust	2"	4'	12'	28"	1	
QUPH	Quercus phellos	Willow Oak	2"	4'	12'	28"	1	

PLANTING NOTES

- 1. REQUIREMENTS FOR THE MEASUREMENT, BRANCHING, GRADING, BALLING AND BURLAPPING OF PLANTS IN THE PLANT LIST GENERALLY FOLLOWS OR EXCEEDS A CODE OF STANDARDS CURRENTLY RECOMMENDED BY THE AMERICAN ASSOCIATION OF NURSERYMEN, INC. IN THE AMERICAN STANDARD FOR NURSERY STOCK. SEE THE PLANT LIST FOR OTHER REQUIREMENTS.
- 2. ALL PLANTS SHALL HAVE A WELL FORMED HEAD WITH MINIMUM CALIPER, HEIGHT AND SPREAD OF THE SIDE BRANCHES AS SHOWN ON THE PLANT LIST. TRUNKS SHALL BE UNDAMAGED AND SHAPE SHALL BE TYPICAL OF THE SPECIES.
- 3. CONTAINERIZED TAXUS OR TAXUS WITH SAND BALLS ARE NOT PERMITTED ON THIS PROJECT. TAXUS MUST BE SUPPLIED BALLED AND BURLAPPED WITH A CLAY LOAM SOIL SIMILAR TO THAT FOUND ON THE SITE.
- 4. PLANTS SHALL BE SOUND, HEALTHY, VIGOROUS AND FREE FROM INSECTS, PESTS, PLANT DISEASES AND INJURIES. ALL PLANTS SHALL EQUAL OR EXCEED THE MEASUREMENTS SPECIFIED IN THE PLANT LIST WHICH ARE MINIMUM ACCEPTABLE SIZES. THEY SHALL BE MEASURED BEFORE PRUNING.
- 5. SYNTHETIC BURLAP SHALL NOT BE USED IN BALLING AND BURLAPPING ANY PLANTS ON THIS PROJECT. THE CONTRACTOR SHALL BE RESPONSIBLE FOR INSURING THAT THIS REQUIREMENT IS MET.
- 6. THE LANDSCAPE CONTRACTOR SHALL BE RESPONSIBLE FOR STAKING AND LAYOUT OF PLANTINGS IN THIS PROJECT. THE LANDSCAPE ARCHITECT OR OWNER SHALL BE ADVISED WHEN STAKES ARE READY FOR INSPECTION OF VARIOUS PLANTING AREAS. ALL LAYOUT WORK SHALL BE INSPECTED AND APPROVED BY THE LANDSCAPE ARCHITECT OR OWNER PRIOR TO OPENING ANY PLANTING PITS.
- 7. SHOULD THE LANDSCAPE CONTRACTOR ENCOUNTER UNSATISFACTORY SURFACE OR SUBSURFACE DRAINAGE CONDITIONS, SOIL DEPTH, LATENT SOILS, HARD PAN, UTILITY LINES OR OTHER CONDITIONS THAT WILL JEOPARDIZE THE HEALTH AND VIGOR OF THE PLANTS, HE MUST ADVISE THE LANDSCAPE ARCHITECT IN WRITING OF THE CONDITIONS PRIOR TO INSTALLING THE PLANTS. OTHERWISE THE LANDSCAPE CONTRACTOR WARRANTS THAT THE PLANTING AREAS ARE SUITABLE FOR PROPER GROWTH AND DEVELOPMENT OF THE PLANTS TO BE INSTALLED.
- 8. IT IS THE RESPONSIBILITY OF THE LANDSCAPE CONTRACTOR TO VERIFY THAT EACH EXCAVATED TREE OR SHRUB PIT WILL PERCOLATE (DRAIN) PRIOR TO ADDING TOPSOIL AND INSTALLING TREES OR SHRUBS. THE CONTRACTOR SHALL FILL THE BOTTOM OF SELECTED HOLES WITH SIX (6) INCHES OF WATER. THIS WATER SHOULD PERCOLATE OUT WITHIN A TWENTY—FOUR (24) HOUR PERIOD. THE LAND—SCAPE ARCHITECT SHALL VERIFY ACCURACY AND EFFECT OF PERCOLATION TEST—ING. IF THE SOIL AT A GIVEN AREA DOES NOT DRAIN PROPERLY, A PVC DRAIN OR GRAVEL SUMP SHALL BE INSTALLED OR THE PLANTING RELOCATED.
- 9. TOPSOIL SHALL BE ORIGINAL SURFACE LOAM OBTAINED FROM WELL-DRAINED AREAS FROM WHICH TOPSOIL HAS NOT BEEN REMOVED PREVIOUSLY, EITHER BY EROSION, CLEARING AND REMOVAL OF TREES OR MECHANICAL MEANS. IT SHALL NOT CONTAIN SUBSOIL MATERIAL AND SHALL BE CLEAN AND FREE OF CLAY LUMPS, ROOTS, STONES OR SIMILAR SUBSTANCES MORE THAN 1" IN DIAMETER, DEBRIS, DISCARDED FRAGMENTS OF BUILDING MATERIALS OR WEEDS AND WEED SEEDS. TOPSOIL SHALL BE CLASSIFIED AS A LOAM, SILT LOAM, CLAY LOAM OR A COMBINATION THEREOF, AS DETERMINED FROM THE BUREAU OF PLANT INDUSTRY SOILS AND AGRICULTURAL ENGINEERING, U.S.D.A. TRIANGULAR SOIL TEXTURE CHART. IT SHALL BE RICH, FRIABLE LOAM CONTAINING NOT LESS THAN THREE (3) PERCENT NOR MORE THAN TEN (10) PERCENT, BY WEIGHT, OF ORGANIC MATTER.
- 10. PLANTING PITS FOR TREES AND SHRUBS SHALL BE DUG A FULL TWELVE (12) INCHES WIDER THAN THE BALL AROUND THE ENTIRE PLANT AND SIX (6) INCHES DEEPER THAN THE BALL. NEW TOPSOIL AS SHALL BE FURNISHED BY THE CONTRACTOR. ANY HEAVY CLAY OR OTHER SOIL UNSUITABLE FOR PLANTING ENCOUNTERED IN THE BOTTOM OF THE HOLES SHALL BE REMOVED FROM THE SITE. IF THE LANDSCAPE CONTRACTOR ENCOUNTERS SOILS THAT ARE SUITABLE FOR BACKFILL, HE SHALL ADVISE THE LANDSCAPE ARCHITECT PRIOR TO BACKFILLING. A WRITTEN CHANGE ORDER WITH A CREDIT TO THE OWNER MAY BE PREPARED TO ALLOW THE CONTRACTOR TO USE EXISTING SOILS AS BACKFILL.
- 11. ALL EXCAVATIONS MADE WITH AN AUGER SHALL HAVE THE ENTIRE SIDE OF THE PLANTING PIT SCARIFIED TO A MINIMUM DEPTH OF ONE (1) INCH.

12. NO EXCAVATION OR PLANTING PIT SHALL BE LEFT UNATTENDED OR OPEN OVERNIGHT.

- 13. SHREDDED HARDWOOD BARK MULCH SHALL BE APPLIED TO ALL SHRUB BEDS BY THE LANDSCAPE CONTRACTOR. BEDS SHALL BE TREATED WITH PRE-EMERGENT HERBICIDE BY THE LANDSCAPE CONTRACTOR BEFORE MULCH IS APPLIED. MULCH SHALL BE AN APPROVED, CLEAN, SHREDDED HARDWOOD BARK OF UNIFORM SIZE NOT TO EXCEED A LENGTH OF THREE (3) INCHES OR A THICKNESS OF ONE-HALF (1/2) INCH. IT SHALL BE DE-CAY AND FIRE RESISTANT, NON-TOXIC TO PLANT MATERIAL AND BE SCREENED TO RE-MOVE SAWDUST AND FINE SHAVINGS AND AGED TO OBTAIN A DARK BROWN COLOR. A SAMPLE OF MULCH SHALL BE PRESENTED TO THE OWNER FOR APPROVAL.
- 14. ALL TREES ARE TO BE STAKED IMMEDIATELY AFTER PLANTING. WRAPPING SHALL NOT BE REQUIRED ON THIS PROJECT.
- 15. ALL CORDS AND BINDINGS SHALL BE CUT FROM PLANTS PRIOR TO PLANTING.
- 16. THE LANDSCAPE CONTRACTOR SHALL BE RESPONSIBLE FOR ALL REQUIRED MAINTENANCE UNTIL ALL PLANTINGS ARE FORMALLY ACCEPTED. ALL PLANTS SHALL BE WATERED AT TIME OF INSTALLATION AND AS OFTEN THEREAFTER AS NECESARY TO MAINTAIN THEM IN A HEALTHY, VIGOROUS CONDITION UNTIL COMPLETION OF WORK AND ACCEPTANCE BY OWNER.
- 17. THE OWNER SHALL BE RESPONSIBLE FOR LANDSCAPE MAINTENANCE AFTER THE PLANTINGS ARE FORMALLY ACCEPTED DURING THE ONE (1) YEAR GUARANTEE PERIOD. THE LANDSCAPE CONTRACTOR SHALL PROVIDE THEM WITH WRITTEN INSTRUCTIONS FOR THE CARE OF THE PLANTINGS DURING THE WARRANTY PERIOD.
- 18. THE LANDSCAPE CONTRACTOR SHALL MAINTAIN THE SITE IN A REASONABLY NEAT AND CLEAN STATE THROUGHOUT THE INSTALLATION PROCESS. STREETS AND PAVED AREAS SHALL BE CLEANED REGULARLYN TO REMOVE DEBRIS RESULTING FROM WORK ON THIS PROJECT.
- 19. PLANTS SHALL BE GUARANTEED FOR THE DURATION OF ONE (1) FULL YEAR AFTER THE FORMAL ACCEPTANCE OF THE PLANTING BY THE OWNER AND SHALL BE ALIVE AND IN SATISFACTORY CONDITION AT THE END OF THE GUARANTEE PERIOD. ANY PLANT NOT IN A HEALTHY AND VIGOROUS STATE AT THE END OF THE GUARANTEE PERIOD SHALL BE REPLACED AT NO COST TO THE OWNER. PLANTS SEVERLY DAMAGED THROUGH VANDALISM ARE NOT SUBJECT TO REPLACEMENT BY THIS CONTRACTOR.
- 20. ALL PLANTS ARE TO BE ALIVE, HEALTHY AND VIGOROUS AT THE TIME OF THE FINAL INSPECTION. ANY PLANT THAT DOES NOT MEET THIS CONDITION SHALL BE REINSTALLED IMMEDIATELY OR AS SOON AS WEATHER CONDITIONS PERMIT AT NO EXPENSE TO THE OWNER.
- 21. REPLACEMENT OF DEAD OR UNSATISFACTORY MATERIAL SHALL BE MADE AS SPECIFIED IN THE PLANT LIST. THE OWNER OR LANDSCAPE ARCHITECT SHALL INSPECT REPLACED PLANTS WHEN ALL REPLACEMENTS HAVE BEEN MADE. REPLACEMENTS ARE TO BE ALIVE AND IN A HEALTHY CONDITION WHEN THE REPLACEMENT IS COMPLETE, BUT THEY SHALL NOT BE SUBJECT TO A ONE (1) YEAR GUARANTEE. THE LANDSCAPE CONTRACTOR SHALL REMOVE THE STAKING AT THE TIME THE REPLACEMENTS ARE MADE.
- 22. SHOULD THE LANDSCAPE CONTRACTOR NOT MAKE REPLACEMENTS IN A SATISFACTORY AND TIMELY FASHION IN ACCORD WITH THE PLANTING NOTES, THE OWNER AFTER PROPER NOTIFICATION TO THE LANDSCAPE CONTRACTOR, MAY UTILIZE THE FUNDS OF RETAINAGE TO HAVE REPLACEMENTS MADE IN ACCORD WITH THE PLANTING NOTES, BY THE LANDSCAPE CONTRACTOR.

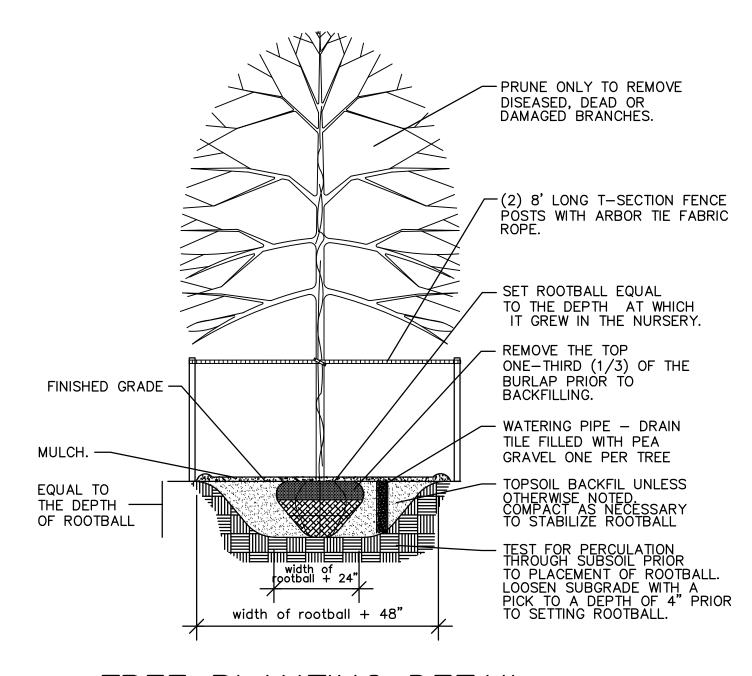

TREE PLANTING DETAIL

RECORD DRAWINGS

THESE RECORD DRAWINGS HAVE BEEN PREPARED BASED ON INFORMATION COMPILED AND FURNISHED BY OTHERS. THE ENGINEER HAS NOT VERIFIED THE ACCURACY AND/OR COMPLETENESS OF THIS INFORMATION AND SHALL NOT BE RESPONSIBLE FOR ANY ERRORS OR OMISSIONS WHICH MAY BE INCORPORATED HEREIN AS A RESULT.

DESIGNER JTK DATE BY REVISION

DRAWN DMB GRAPHIC SCALE

CHECKED AGC
APPROVED RLP SCALE: AS NOTED

ALL RIGHTS RESERVED

THIS DOCUMENT IS THE PROPERTY OF BELL
ENGINEERING AND SHALL NOT BE REPRODUCED
N WHOLE OR IN PART OR USED FOR CONSTRUCTION
OF OTHER THAN THIS SPECIFIC PROJECT WITHOUT
THE WRITTEN PERMISSION OF BELL ENGINEERING.
FACSIMILES OF LICENSED PROFESSIONAL ENGINEER
AND/OR LAND SURVEYOR SEALS, IF AFFIXED TO
THIS DOCUMENT, SHALL BE CONSIDERED LEGITIMATE
ONLY IF SIGNED AND DATED BY THE REGISTRANT.

OF KENNON TO JOSHUA TO JOS

oell engineering

Lexington, KY (859) 278-5412 CA
Hopkinsville, KY (270) 886-5466

2393.0 SOUTH CAMPUS PARKING LOT CAPITAL PROJECT MANAGEMENT DIVISION UNIVERSITY OF KENTUCKY LEXINGTON, KENTUCKY


LANDSCAPING DETAILS

DIVISION LANDSCAPING

CONTRACT NO. 600-037

DATE APRIL 2014

SHEET NO. L11

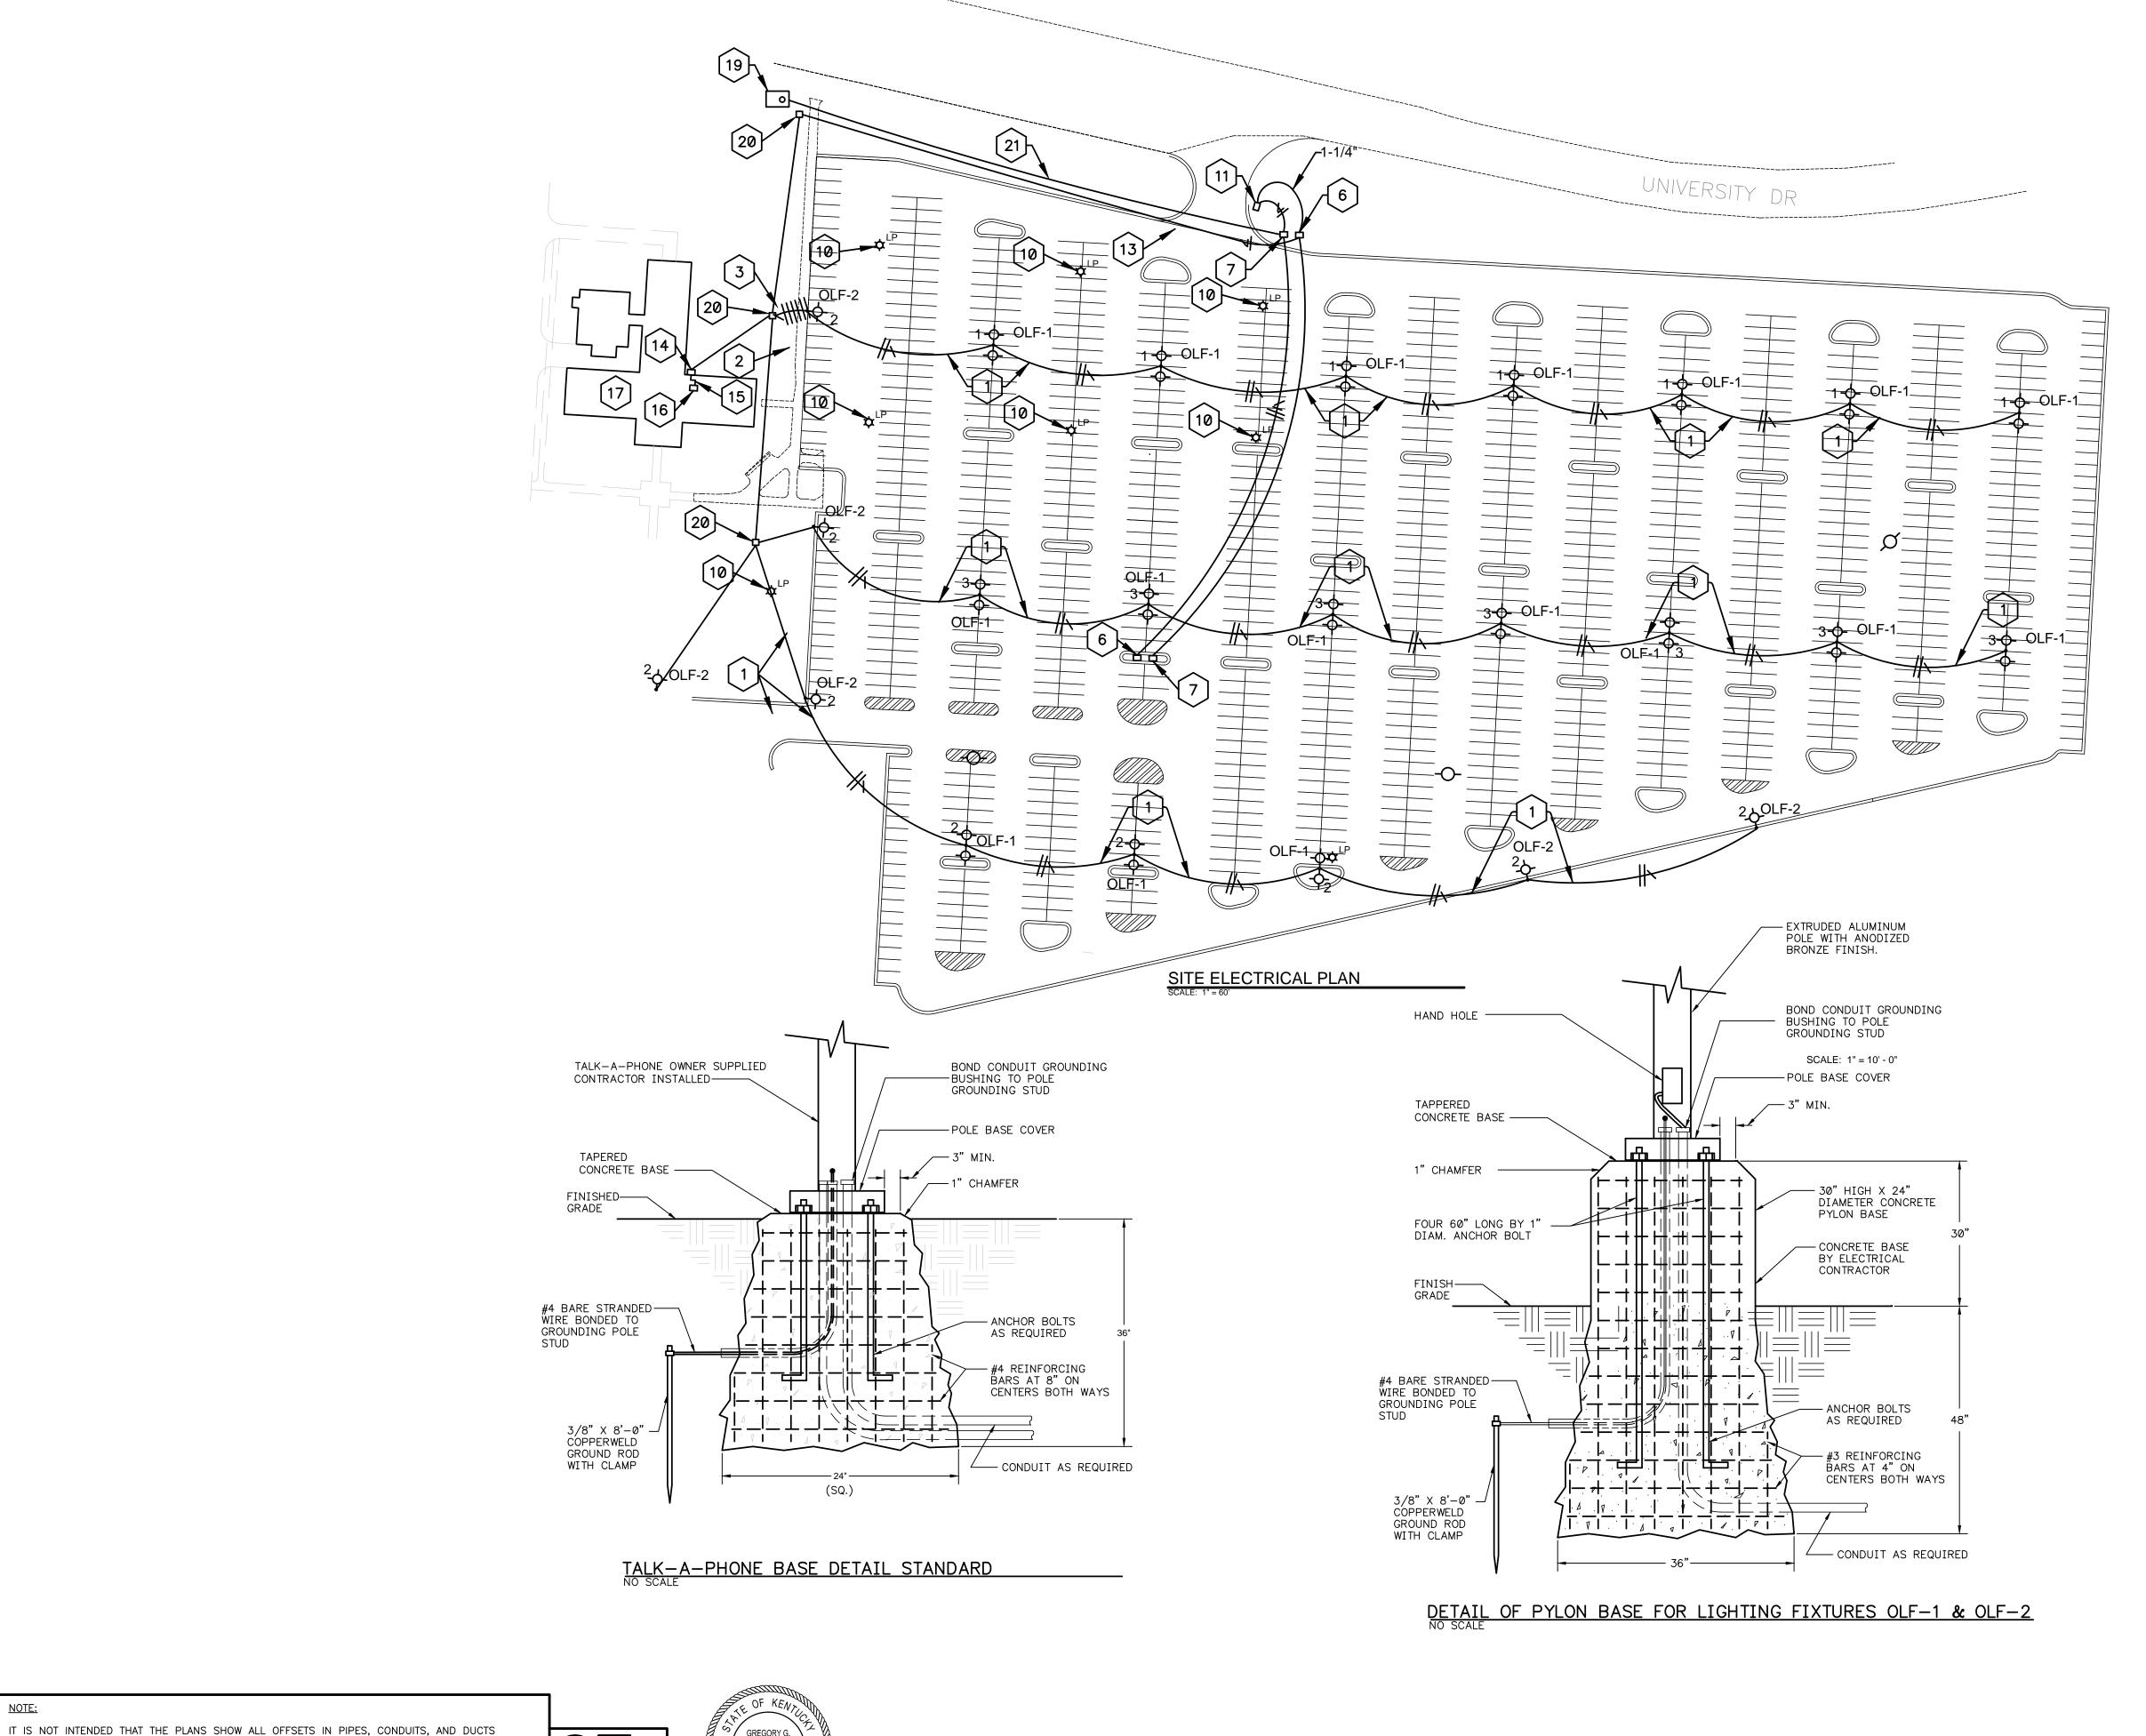

GENERAL NOTES: SITE UTILITIES

- A THE CONTRACT DOCUMENTS SHOW THE APPROXIMATE LOCATION OF THE EXISTING AND NEW SUBSURFACE UTILITY LINES. THESE LINES HAVE BEEN IDENTIFIED AND LOCATED AS ACCURATELY AS POSSIBLE USING AVAILABLE INFORMATION. THE CONTRACTOR IS RESPONSIBLE FOR VERIFYING ALL ACTUAL LOCATIONS. IF ANY CHARTED, UNCHARTED OR MISLOCATED UTILITY SERVICE IS INTERRUPTED FOR ANY REASON, THE CONTRACTOR WILL WORK CONTINUOUSLY TO RESTORE SERVICE TO THE SATISFACTION OF THE OWNER.
- B THE CONTRACTOR IS RESPONSIBLE FOR LOCATING ALL EXISTING UNDERGROUND UTILITIES PRIOR TO EXCAVATING. THE OWNER WILL NOT LOCATE THESE UTILITIES FOR THE CONTRACTOR. IF AN OUTSIDE SERVICE OR COMPANY IS REQUIRED TO ACCURATELY LOCATE BURIED UTILITIES THE CONTRACTOR IS RESPONSIBLE FOR SCHEDULING THIS WORK AND IS RESPONSIBLE FOR THE COSTS. THE CONTRACTOR SHOULD CONTACT APPROPRIATE UTILITY COMPANIES BEFORE DOING ANY EXCAVATING.
- C LOCATIONS OF UTILITIES ARE APPROXIMATE AND SUBJECT TO MINOR CHANGES IN THE FIELD. DO NOT SCALE THE DRAWINGS.
- D INSTALL UNDERGROUND BRANCH CIRCUITS WITH 2'-0' MINIMUM COVER.
- E <u>EXCAVATION</u>: MATERIALS TO BE EXCAVATED SHALL INCLUDE EARTH AND ANY OTHER MATERIAL, INCLUDING ROCK, ENCOUNTERED IN THE TRENCH EXCAVATION.
- F SITE LIGHTING CIRCUITS SHALL BE MINIMUM #6 CONDUCTORS IN 1 -

CODED NOTES:

- 1. 2#6'S (2 HOTS) AND 1#8 GND. IN 1-1/4"C.
- 2. 4#6'S (4 HOTS) AND 1#8 GND. IN 1-1/4"C.
- 3. 6#6'S (6 HOTS) AND 1#8 GND. IN 1-1/4"C. TO 3 NEW 20A/2P BREAKERS IN EXISTING PANELBOARD.
- CONNECT NEW CONDUIT TO EXISTING PULL BOX. PULL NEW WIRING INTO EXISTING PANELBOARD.
- 5. EXISTING PANELBOARD. PROVIDE 3-20A/2P BREAKERS TO FEED NEW LIGHTS, 120A/1P TO FEED TALK-A-PHONE.
- 6. 12"x15"x24" DEEP SOLID BOTTOM FRP STRAIGHT QUAZITE IN GROUND BOX WITH GASKETED TWO BOLT COVER TIER 15 (15,000/22,000 LB) LOAD RATING. LABEL BOXES "ELECTRIC" FOR POWER AND "COMMUNICATIONS" FOR FIBER. FINAL BOX LOCATIONS WILL BE FIELD

LOCATED AND MAY MOVE TO PARKING ROWS TO THE SOUTH.

- 7. EXTEND #10'S AND #8 GND. TO TALK-A-PHONE FOR 120V POWER. COIL #6'S IN PULL BOX FOR FUTURE EXTENSION TO BUS STOP. FINAL BOX LOCATIONS WILL BE FIELD LOCATED AND MAY MOVE TO PARKING ROWS TO THE SOUTH.
- 8. EMERGENCY CALL BOX. PROVIDE 1-1"C. TO COMMUNICATION ROOM IN GOOD BARN FOR FUTURE.
- 9. 2#6'S AND 1#8 GND. TO NEW 20A/1P BREAKER IN PANELBOARD IN THE GOOD BARN.
- 10. REMOVE EXISTING LIGHT FIXTURE CONCRETE BASE AND ALL BRANCH CIRCUIT WIRING. SALVAGE AND DELIVER FIXTURE AND POLE TO THE
- 11. TALK-A-PHONE. PROVIDE POWER AND COMMUNICATION CONDUIT.12. CONDUIT FOR FIBER. FIBER TO BE INSTALLED BY OWNER.
- 13. 3#6'S (TWO HOTS AND ONE NEUTRAL) AND 2#10'S (2 HOTS AND ONE
- NEUTRAL) AND 1#8 GND.

 14. TERMINATE POWER FEEDS INTO EXISTING EXTERIOR PULL BOX AFTER REMOVING EXISTING CONDUIT AND BRANCH CIRCUIT WIRING THAT FEED EXISTING LIGHTS.
- 15. INSTALL NEW WIRING IN EXISTING 1-1/4" CONDUIT. TERMINATE WIRE FOR NEW LIGHTS AND TALK-A-PHONE. PULL WIRING FOR THE FUTURE BUS SHELTER IN AND MAKE FOR SPARE IN PANELBOARD GUTTER.
- 16. EXISTING SQUARE D PANELBOARD. PROVIDE 3 NEW 20A/2P, AND 1 20A/1P BREAKERS FOR NEW LIGHTS AND TALK-A-PHONE. MARK EXISTING LIGHTING BREAKERS AS SPARE FOR FUTURE BUS STOP.
- 17. CONNECT TO EXISTING SURFACE MOUNTED COMMUNICATION PULL BOX.18. 1-1/4" CONDUIT FOR OWNER INSTALLED FIBER.
- 19. EXISTING COMMUNICATIONS MANHOLE.
- 20. NEW QUAZITE BOX.
- 21. 2" PVC FOR FUTURE FIBER OPTIC CABLE.

LIGHT FIXTURE SCHEDULE:

OLF-1 LED AREA LIGHT WITH LOW COPPER DIECAST ALUMINUM FINNED HOUSING, REMOVEABLE POWER DOOR, STAINLESS STEEL LATCHES, CAST ALUMINUM ARCHITECTURAL POLE MOUNTING ARM, 100,000 HOUR L70 RATED LIFE LED LIGHT ENGINE, TYPE II MEDIUM DISTRIBUTION 24,718 DELIVERED LUMEN LED ARRAY, CSA LISTED FOR WET LOCATIONS, AND LIMITED FIVE YEAR WARRANTY. TWO FIXTURES TO BE MOUNTED TO A 40' STRAIGHT SQUARE ALUMINUM POLE.

HOLOPHANE MGLED 6COB 5K IIM L A SSS40 DM19 LITHONIA EQUAL

OLF-2 LED AREA LIGHT WITH LOW COPPER DIECAST ALUMINUM FINNED HOUSING, REMOVEABLE POWER DOOR, STAINLESS STEEL LATCHES, CAST ALUMINUM ARCHITECTURAL POLE MOUNTING ARM, 100,000 HOUR L70 RATED LIFE LED LIGHT ENGINE, TYPE II MEDIUM DISTRIBUTION 24,718 DELIVERED LUMEN LED ARRAY, CSA LISTED FOR WET LOCATIONS, AND LIMITED FIVE YEAR WARRANTY. ONE FIXTURE TO BE MOUNTED TO A 40' STRAIGHT SQUARE STEEL POLE AT 180 DEGREES.

HOLOPHANE MGLED 6COB 5K IIM L A SSS40 DM28 LITHONIA EQUAL

RECORD DRAWINGS

THESE RECORD DRAWINGS HAVE BEEN PREPARED BASED ON INFORMATION COMPILED AND FURNISHED BY OTHERS. THE ENGINEER HAS NOT VERIFIED THE ACCURACY AND/OR COMPLETENESS OF THIS INFORMATION AND SHALL NOT BE RESPONSIBLE FOR ANY ERRORS OR OMISSIONS WHICH MAY BE INCORPORATED HEREIN AS A RESULT.

DESIGNER DESIGNER	DATE	BY	REVISION	
DRAWN DRAWN				GRAPHIC SCALE
DIAWN DIAWN				GRAPHIC SCALE
CHECKED CHECKED?				

Staggs and Fisher
Consulting Engineers, Inc.
3264 Lochness Drive Lexington, Kentucky 40517
(889) 271–3246

SCALE: AS NOTED ON DWG

REQUIRED FOR INSTALLATION OF THE WORK. DETAILS AND SECTIONS ARE INCLUDED FOR SOME

AREAS TO SHOW INTENDED RELATIONSHIP OF THE WORK OF VARIOUS TRADES. IT SHALL BE THE

RESPONSIBILITY OF THE CONTRACTOR AND SUB-CONTRACTORS TO COORDINATE INSTALLATION OF

THE WORK AND TO PROVIDE THE NECESSARY OFFSETS, TRANSFORMATIONS AND FITTINGS REQUIRED.

NO ADDITIONAL COMPENSATION WILL BE ALLOWED FOR CORRECTING CONFLICTS BETWEEN THE WORK

OF VARIOUS TRADES. DETAILS AND SECTIONS ARE SHOWN FOR THE CONTRACTORS CONVENIENCE

AND SHALL NOT BE CONSIDERED COMPLETE IN EVERY DETAIL.

APPROVED APPROVED

THIS DOCUMENT IS THE PROPERTY OF BELL ENGINEERING AND SHALL NOT BE REPRODUCED IN WHOLE OR IN PART OR USED FOR CONSTRUCTION OF OTHER THAN THIS SPECIFIC PROJECT WITHOUT THE WRITTEN PERMISSION OF BELL ENGINEERING.

FACSIMILES OF LICENSED PROFESSIONAL ENGINEER AND/OR LAND SURVEYOR SEALS, IF AFFIXED TO THIS DOCUMENT, SHALL BE CONSIDERED LEGITIMATE ONLY IF SIGNED AND DATED BY THE REGISTRANT.

ALL RIGHTS RESERVED

Lexington, KY (859) 278-5412 Hopkinsville, KY (270) 886-5466 2393.0 SOUTH CAMPUS PARKING LOT CAPITAL PROJECT MANAGEMENT DIVISION UNIVERSITY OF KENTUCKY LEXINGTON, KENTUCKY

SITE UTILITIES PLAN

DIVISION GENERAL

CONTRACT NO. 600-001

DATE APRIL 2014

SHEET NO. U10