

MECHANICAL LEGEND

| MECHAI | HOAL LEGEND |
|--|--|
| | EXISTING SANITARY (INTERIOR) |
| ES | EXISTING SANITARY SEWER (EXTERIOR) |
| s | NEW SANITARY SEWER (DIVISION 15) |
| — • SAN—— | NEW SANITARY SEWER (DIVISION 2) |
| | EXISTING VENT (SANITARY) |
| ESS | EXISTING STORM SEWER |
| STM | NEW STORM SEWER (DIVISION 2) |
| ERL | EXISTING ROOF LEADER |
| EFS | EXISTING FUEL SUPPLY |
| EFR | EXISTING FUEL RETURN |
| EW | EXISTING COLD WATER (EXTERIOR) |
| W | NEW COLD WATER (EXTERIOR) |
| EG | EXISTING GAS |
| SPD—— | NEW SUMP PUMP DISCHARGE |
| EHPS—— | EXISTING HIGH PRESSURE STEAM |
| HPS | NEW HIGH PRESSURE STEAM |
| EPD | EXISTING PUMP DISCHARGE |
| PD | NEW PUMP DISCHARGE |
| ECWS | EXISTING CHILLED WATER SUPPLY |
| ECWR | EXISTING CHILLED WATER RETURN |
| EFL- | EXISTING FIRE LINE |
| FL | NEW FIRE LINE |
| —————————————————————————————————————— | EXISTING COLD WATER (CITY PRESSURE) NEW COLD WATER (CITY PRESSURE) |
| EHWC | EXISTING HOT WATER (CITY PRESSURE) |
| ERS- | EXISTING REHEAT SUPPLY |
| RS | NEW REHEAT SUPPLY |
| | NEW REHEAT RETURN |
| — — — ERR— — — | EXISTING REHEAT RETURN |
| 12 X 6 | DUCT (DOUBLE LINE AND SIZE) |
| MA THE THE PARTY OF THE PARTY O | FLEXIBLE DUCT |
| IIP DOWN | DUCTWORK SECTIONS: |
| | SUPPLY |
| | RETURN, EXHAUST OR OUTSIDE AIR |
| 4 2 | SQUARE TYPE ELBOW WITH TURNING VANES |
| SA | SINGLE LINE DUCTWORK (SUPPLY AIR) |
| F.D. | FIRE DAMPER |
| V.D. | MANUAL VOLUME DAMPER |
| | GATE VALVE |
| N | CHECK VALVE |
| ——⊗—— | VALVE WITH VALVE BOX |
| > | ELBOW (UP, DOWN, SIDE) |
| ⊸ | TEE (UP, DOWN, SIDE) |
| T | NEW THERMOSTAT |
| 团 | EXISTING THERMOSTAT |

WALL HYDRANT

C.I.

W.H.

WITCHEN HY-1 JANITON H4-23 SUPPLY LOOM CORLIDOR HS H36A CONFERENCE MECHANICAL

CODED NOTES: DRAWING M-2

EXISTING THERMOSTAT TO REMAIN.

SEAL AIRTIGHT.

2 REMOVE AND RELOCATE EXISTING THERMOSTAT. SEE PARTIAL FLOOR PLAN ABOVE FOR NEW LOCATION.

3 EXISTING CABINET UNIT HEATER TO REMAIN. 4 REMOVE EXISTING DIFFUSER, 12" DIA. BRANCH SUPPLY DUCT, AND INSULATION. REMOVE BRANCH DUCT BACK TO 18 X 12 DUCT AND BLANK-OFF.

REMOVE EXISTING INSULATION BACK TO THIS POINT.

6 REMOVE AND RELOCATE EXISTING GRILLE AND DUCTWORK. SEE PARTIAL PLAN ABOVE FOR NEW LOCATION.

EXISTING DUCTWORK AND/OR PIPING TO REMAIN. REMOVE EXISTING DIFFUSER, BRANCH DUCT AND INSULATION BACK TO POINT

SHOWN AND BLANK-OFF. SEAL AIRTIGHT. EXISTING EXHAUST OUTLET AND DUCT TO REMAIN.

10 NEW LOCATION OF EXISTING THERMOSTAT. SEE NOTE 2.

11 NEW LOCATION OF EXISTING GRILLE AND DUCTWORK. SEE NOTE 6.

12 CONNECT TO EXISTING 18 X 12 DUCT ABOVE CEILING.

DETAIL THIS DRAWING.

13 NEW THERMOSTAT.


14 CONNECT TO EXISTING 34"RS AND 34"RR PIPING ABOVE CEILING.

15 NEW FIRE DAMPER. SEE DETAIL THIS DRAWING. FIELD VERIFY EXISTING


16 NEW CABINET HEATER, TRANE MODEL B, SIZE 03, 300 CFM, 19,872 BTU/HR, 0.75 GPM, 1/30 MP, 60° EAT, 190° EWT, THROWAWAY FILTER. SEE

17 NEW DIFFUSER, ANEMOSTAT TYPE EPL-D, SIZE 8", 275 GFM, 4-WAY, .015 P.D., 24 X 24 LAY-IN, 21 N.C., WHITE BAKED ENAMEL FINISH. SEE DETAIL THIS DRAWING.

18 NEW DIFFUSER, ANEMOSTAT, TYPE EPL-D, SIZE 12", 525 CFM, 4-WAY, .015 P.D., 24 X 24 LAY-IN, 23 N.C., WHITE BAKED ENAMEL FINISH. SEE DETAIL THIS DRAWING.

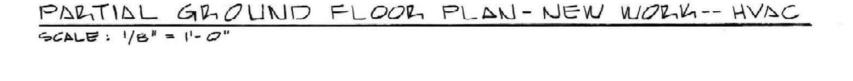

PLAN NORTH

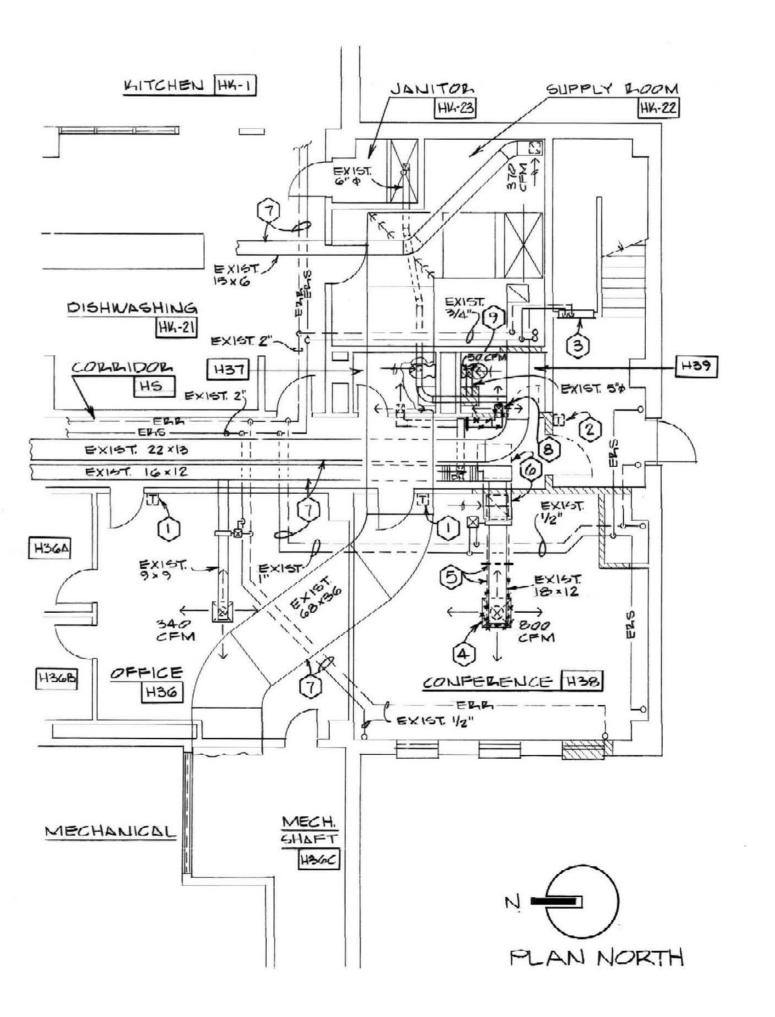

PARTIAL GROUND FLOOR PLAN-DEMOLITION -- HVAC SCALE: 1/8" = 1'-0"

RECORD DRAWINGS DATE 9/13/90 These record drawings have been prepared, in part, on the basis of information compiled and furnished by others. The Engineer will not be responsible for any errors or omissions which have been incorporated into this document as

STAGGS & FISHER CONSULTING ENGINEERS, INC.

M-2

ENTER UNIVERSIT CHANDLER MEDICAL

XPANSION

University of Kentucky

Drawn by Check by: O.G.C. Revisions:

HOSPITAL ADDITION