

Benchmark - Finished Floor inside Research Facility No. 2 Elev. 979.41'

U.K. MEDICAL CENTER (Existing Building) First Floor Elev. - 993.95 Ground Floor Elev. - 979.03

RESEARCH FACILITY No. 2 (Existing Building) First Floor Elev. - 979.41

HEATING AND COOLING PLANT

PROPOSED HOSPITAL EXPANSION


Proposed Parking Structure

NOTE: Location of proposed hospital expansion, as shown, was taken from a reduced size plan sheet entitled "University of Kentucky Medical Center Expansion - Ground Floor Plan" dated 11/25/86, received from Omni Architects on 11/26/86.

Topographic and Survey information for the boring layout was taken from a survey drawing supplied by Omni Architects, Lexington, Kentucky. The information is believed to be correct, but is not to be used by the contractor for construction of the project.

BORING LOCATIONS			
Boring No.	Station	Offset	Surface Elevation (Ft.)
1	0+33	4' Lt.	980.7
2	0+67	4' Lt.	980.3
3	0+95	1' Lt.	979.3
4	1+25	4' Lt.	977.9
5	1+53	4' Lt.	977.4
6	1+73	4' Lt.	976.7
7	0+30	9' Rt.	978.9
8	0+88	24' Rt.	976.8
9	1+76	31' Rt.	973.7
10	2+06	31' Rt.	973.1
11	0+08	53' Rt.	978.3
12	0+31	44' Rt.	978.5
13	0+66	40' Rt.	979.0
14	0+99	48' Rt.	975.9
15	1+19	52' Rt.	975.3
16	1+45	57' Rt.	974.4
17	1+76	61' Rt.	974.0
18	0+07	84' Rt.	976.5
19	1+00	84' Rt.	976.3
20	1+19	84' Rt.	975.7
21	1+49	85' Rt.	975.2
22	1+75	90' Rt.	974.3
23	2+08	100' Rt.	973.6
24	0+07	114' Rt.	978.8
25	0+99	115' Rt.	976.8
26	1+19	114' Rt.	976.4
27	1+49	112' Rt.	975.5
28	0+08	148' Rt.	978.7
29	0+98	145' Rt.	977.3
30	1+20	144' Rt.	976.6
31	1+47	146' Rt.	975.8
32	1+77	137' Rt.	974.8
33	2+06	136' Rt.	974.0
34	0+07	172' Rt.	979.0
35	0+97	172' Rt.	977.2
36	1+19	172' Rt.	976.7
37	1+46	175' Rt.	975.9
38	1+74	166' Rt.	974.9
39	0+08	200' Rt.	978.9
40	0+99	200' Rt.	977.2
41	1+10	200' Rt.	976.8
42	1+40	197' Rt.	976.0
43	1+76	202' Rt.	974.7
44	1+99	200' Rt.	974.1
45	-0+11	220' Rt.	982.5
46	1+35	222' Rt.	975.8
47	1+76	222' Rt.	974.7
48	2+16	215' Rt.	975.6
49	-0+11	233' Rt.	982.3
50	0+09	234' Rt.	978.8
51	0+98	236' Rt.	976.9
52	1+33	240' Rt.	975.5
53	-0+63	267' Rt.	987.6
54	-0+38	264' Rt.	986.4
55	-0+11	264' Rt.	982.5
56	0+07	274' Rt.	979.0
P-1	0+04	206' Rt.	978.8
P-2	0+20	2' Lt.	980.9
P-3	0+94	110' Rt.	977.7
P-4	1+62	210' Rt.	975.9
P-5	1+62	10' Lt.	978.0
P-6	2+95	116' Rt.	972.1
P-7	2+95	247' Rt.	971.8
P-8	3+33	3' Lt.	977.3
P-9	4+77	222' Rt.	969.5
P-10	4+77	28' Rt.	973.0

ALBERT B. CHANDLER MEDICAL CENTER UNIVERSITY OF KENTUCKY HOSPITAL EXPANSION & RENOVATION

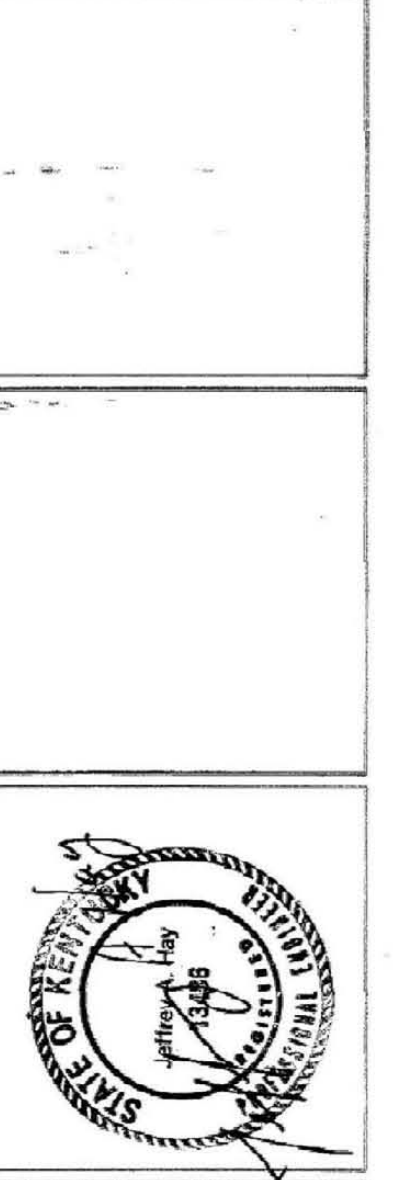

FULLER, MOSSBARGER, SCOTT & MAY  
 CIVIL ENGINEERS, INC.  
 135 LEBSTOWN ROAD, LEXINGTON, KENTUCKY  
 271 E. MAIN STREET, HAZARD, KENTUCKY

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HOSPITAL EXPANSION  
 PARKING GARAGE  
 PROJECT NO. 304.3

University of Kentuck  
 Design & Constructio  
 Approval

Director \_\_\_\_\_

Date \_\_\_\_\_  
 Drawn by \_\_\_\_\_  
 Check by \_\_\_\_\_  
 Revisions \_\_\_\_\_


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**LEGEND**

46 ○ Rockline Sounding

53 ● Soil Boring with Rock Core

P-1 ○ Rockline Sounding advanced and reported April, 1986 (Preliminary Geotechnical Exploration)

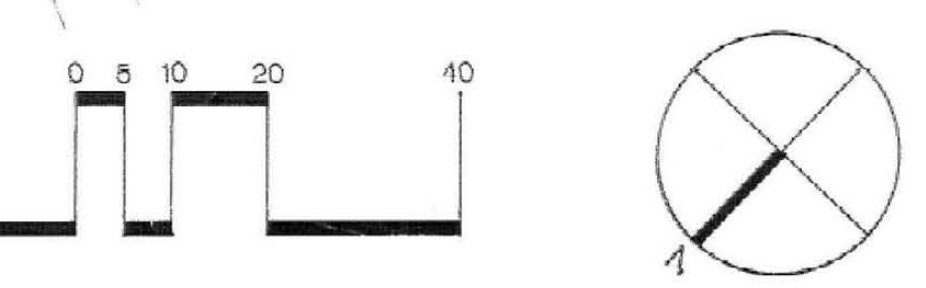

SCALE: 1" = 20'